

DFCM DESIGN AND CODE CRITERIA

APPLICABLE CODES			
Year		Year	
International Building Code	2006	National Electrical Code	2005
International Mechanical Code	2006	Uniform Code for	
International Plumbing Code	2006	Building Conservation	N/A
International Fire Code	2006	ADA Accessibility	
International Energy		Guidelines	2006
Conservation Code	N/A		

- A. Occupancy and Group: B _____ _____ _____ _____
- Change in Use: Yes _____ No X Mixed Occupancy: Yes _____ No X
- Special Use and Occupancy (e.g. High Rise, Covered Mall): NO
- B. Seismic Design Category: 3 Design Wind Speed: N/A mph
- C. Type of Construction (circle one):
- I I II II III IV V V
- A B A B A HT A B
- D. Fire Resistance Rating Requirements for the Exterior Walls based on the fire separation distance (in hours):
- North: N/A South: N/A East: N/A West: N/A
- E. Mixed Occupancies: NO Nonseparated Uses: NO
- F. Sprinklers:
- Required: NO Provided: YES Type of Sprinkler System: WET PIPE
- G. Number of Stories: 1 Building Height: N/A
- H. Actual Area per Floor (square feet): 14,368 actual bldg sq ft
- I. Tabular Area: as per table 503 (23,000 sq ft allowed.)
- J. Area Modifications:
- a) $A_a = A_t + \left[\frac{A_t I_f}{100} \right] + \left[\frac{A_t I_s}{100} \right]$ $I_f = 100 \left[\frac{F}{P} - 0.25 \right] \frac{W}{30}$
- b) Sum of the Ratio Calculations for Mixed Occupancies:
- Actual Area ≤ 1
- Allowable Area
- c) Total Allowable Area for:
- 1) One Story: -
- 2) Two Story: A_a(2) -
- 3) Three Story: A_a(3) -
- d) Unlimited Area Building: Yes _____ No X Code Section: N/A
- K. Fire Resistance Rating Requirements for Building Elements (hours).

Element	Hours	Assembly Listing	Element	Hours	Assembly Listing
Exterior Bearing Walls	0	-	Floors - Ceiling Floors	0	-
Interior Bearing Walls	0	-	Roofs - Ceiling Roofs	0	-
Exterior Non-Bearing Walls	0	-	Exterior Doors and Windows	0	-
Structural Frame	0	-	Shaft Enclosures	N/A	-
Partitions - Permanent	0	-	Fire Walls	0	-
Fire Barriers	0	-	Fire Partitions	0	-
			Smoke Partitions	0	-

- L. Design Occupant Load: XX
- Exit Width Required: XX Exit Width Provided: XX
- M. Minimum Number of Required Plumbing Facilities:
- a) Water Closets - Required (m) XX (f) XX Provided (m) X (f) X
- b) Lavatories - Required (m) XX (f) XX Provided (m) X (f) X
- c) Bath Tubs or Showers: XX
- d) Drinking Fountains: XX Service Sinks: XX


- FOOTNOTES:
- 1) In case of conflict with the U.S. Department of Justice Federal Registers Parts I through V - ADA Guidelines and specific reference to the International Building Code Accessibility Chapters, the more restrictive requirement shall govern.
- 2) Additional Code Information shall be provided at the discretion of the Building Official for Complex Buildings. Including, but not limited to:
- a) High Rise Requirements.
- b) Atriums.
- c) Performance Based Criteria.
- d) Means or Egress Analysis.
- e) Fire Assembly Locator Sheet.
- f) Exterior and Interior Accessibility Route.
- g) Fire Stopping, Including Tested Design Number.

DEPARTMENT OF SAFETY

RICHFIELD ITS UHP DISPATCH MODIFICATIONS

DFCM PROJECT NO. 06298550

RICHFIELD, UTAH 84701

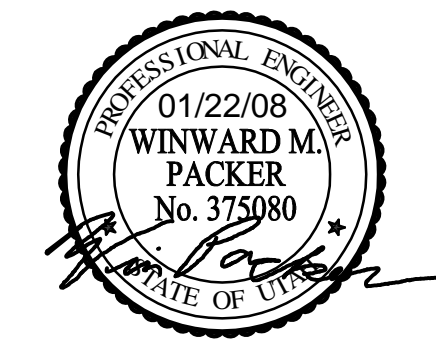

MECHANICAL ENGINEER

WHW ENGINEERING, INC.

1354 EAST 3300 SOUTH

SUITE 200

SALT LAKE CITY, UTAH 84106

PHONE: (801) 466-4021 FAX: (801) 466-8536

ARCHITECT

P + A ARCHITECTS

821 EAST KENSINGTON AVENUE.

SALT LAKE CITY, UTAH 84105

PHONE: (801) 484-1161 FAX: (801) 485-4640

ELECTRICAL ENGINEER

THOMAS & KOLKMAN ENGINEERING CO. INC.

64 WEST 1700 SOUTH


SALT LAKE CITY, UTAH 84115

PHONE: (801) 484-8161 FAX: (801) 484-3538

DRAWING INDEX:

- G000 ----- TITLE SHEET
- A-G001----- ARCHITECTURAL GENERAL INFORMATION
- A-SP101-- SITE PLAN
- A-DP101-- DEMOLITION FLOOR AND CEILING PLAN
- A-FP101-- NEW FLOOR AND CEILING PLAN
- A-DT500-- ARCHITECTURAL DETAIL
- MG001---- MECHANICAL GENERAL NOTES AND LEGEND
- MD101---- MECHANICAL DEMOLITION FLOOR PLAN
- MD102---- MECHANICAL DEMOLITION ROOF PLAN
- ME101---- MECHANICAL FLOOR PLAN
- ME102---- MECHANICAL ROOF PLAN
- ME501---- MECHANICAL DETAILS
- ME601---- MECHANICAL SCHEDULES
- E-101 ----- ELECTRICAL PLANS AND SCHEDULES
- E-102 ----- ROOF ELECTRICAL PLAN
- EL101----- LIGHTING PLANS
- EP101----- POWER PLANS
- FA101----- FIRE ALARM PLANS
- E-601 ---- SYMBOLS LIST, SCHEDULES AND DIAGRAMS



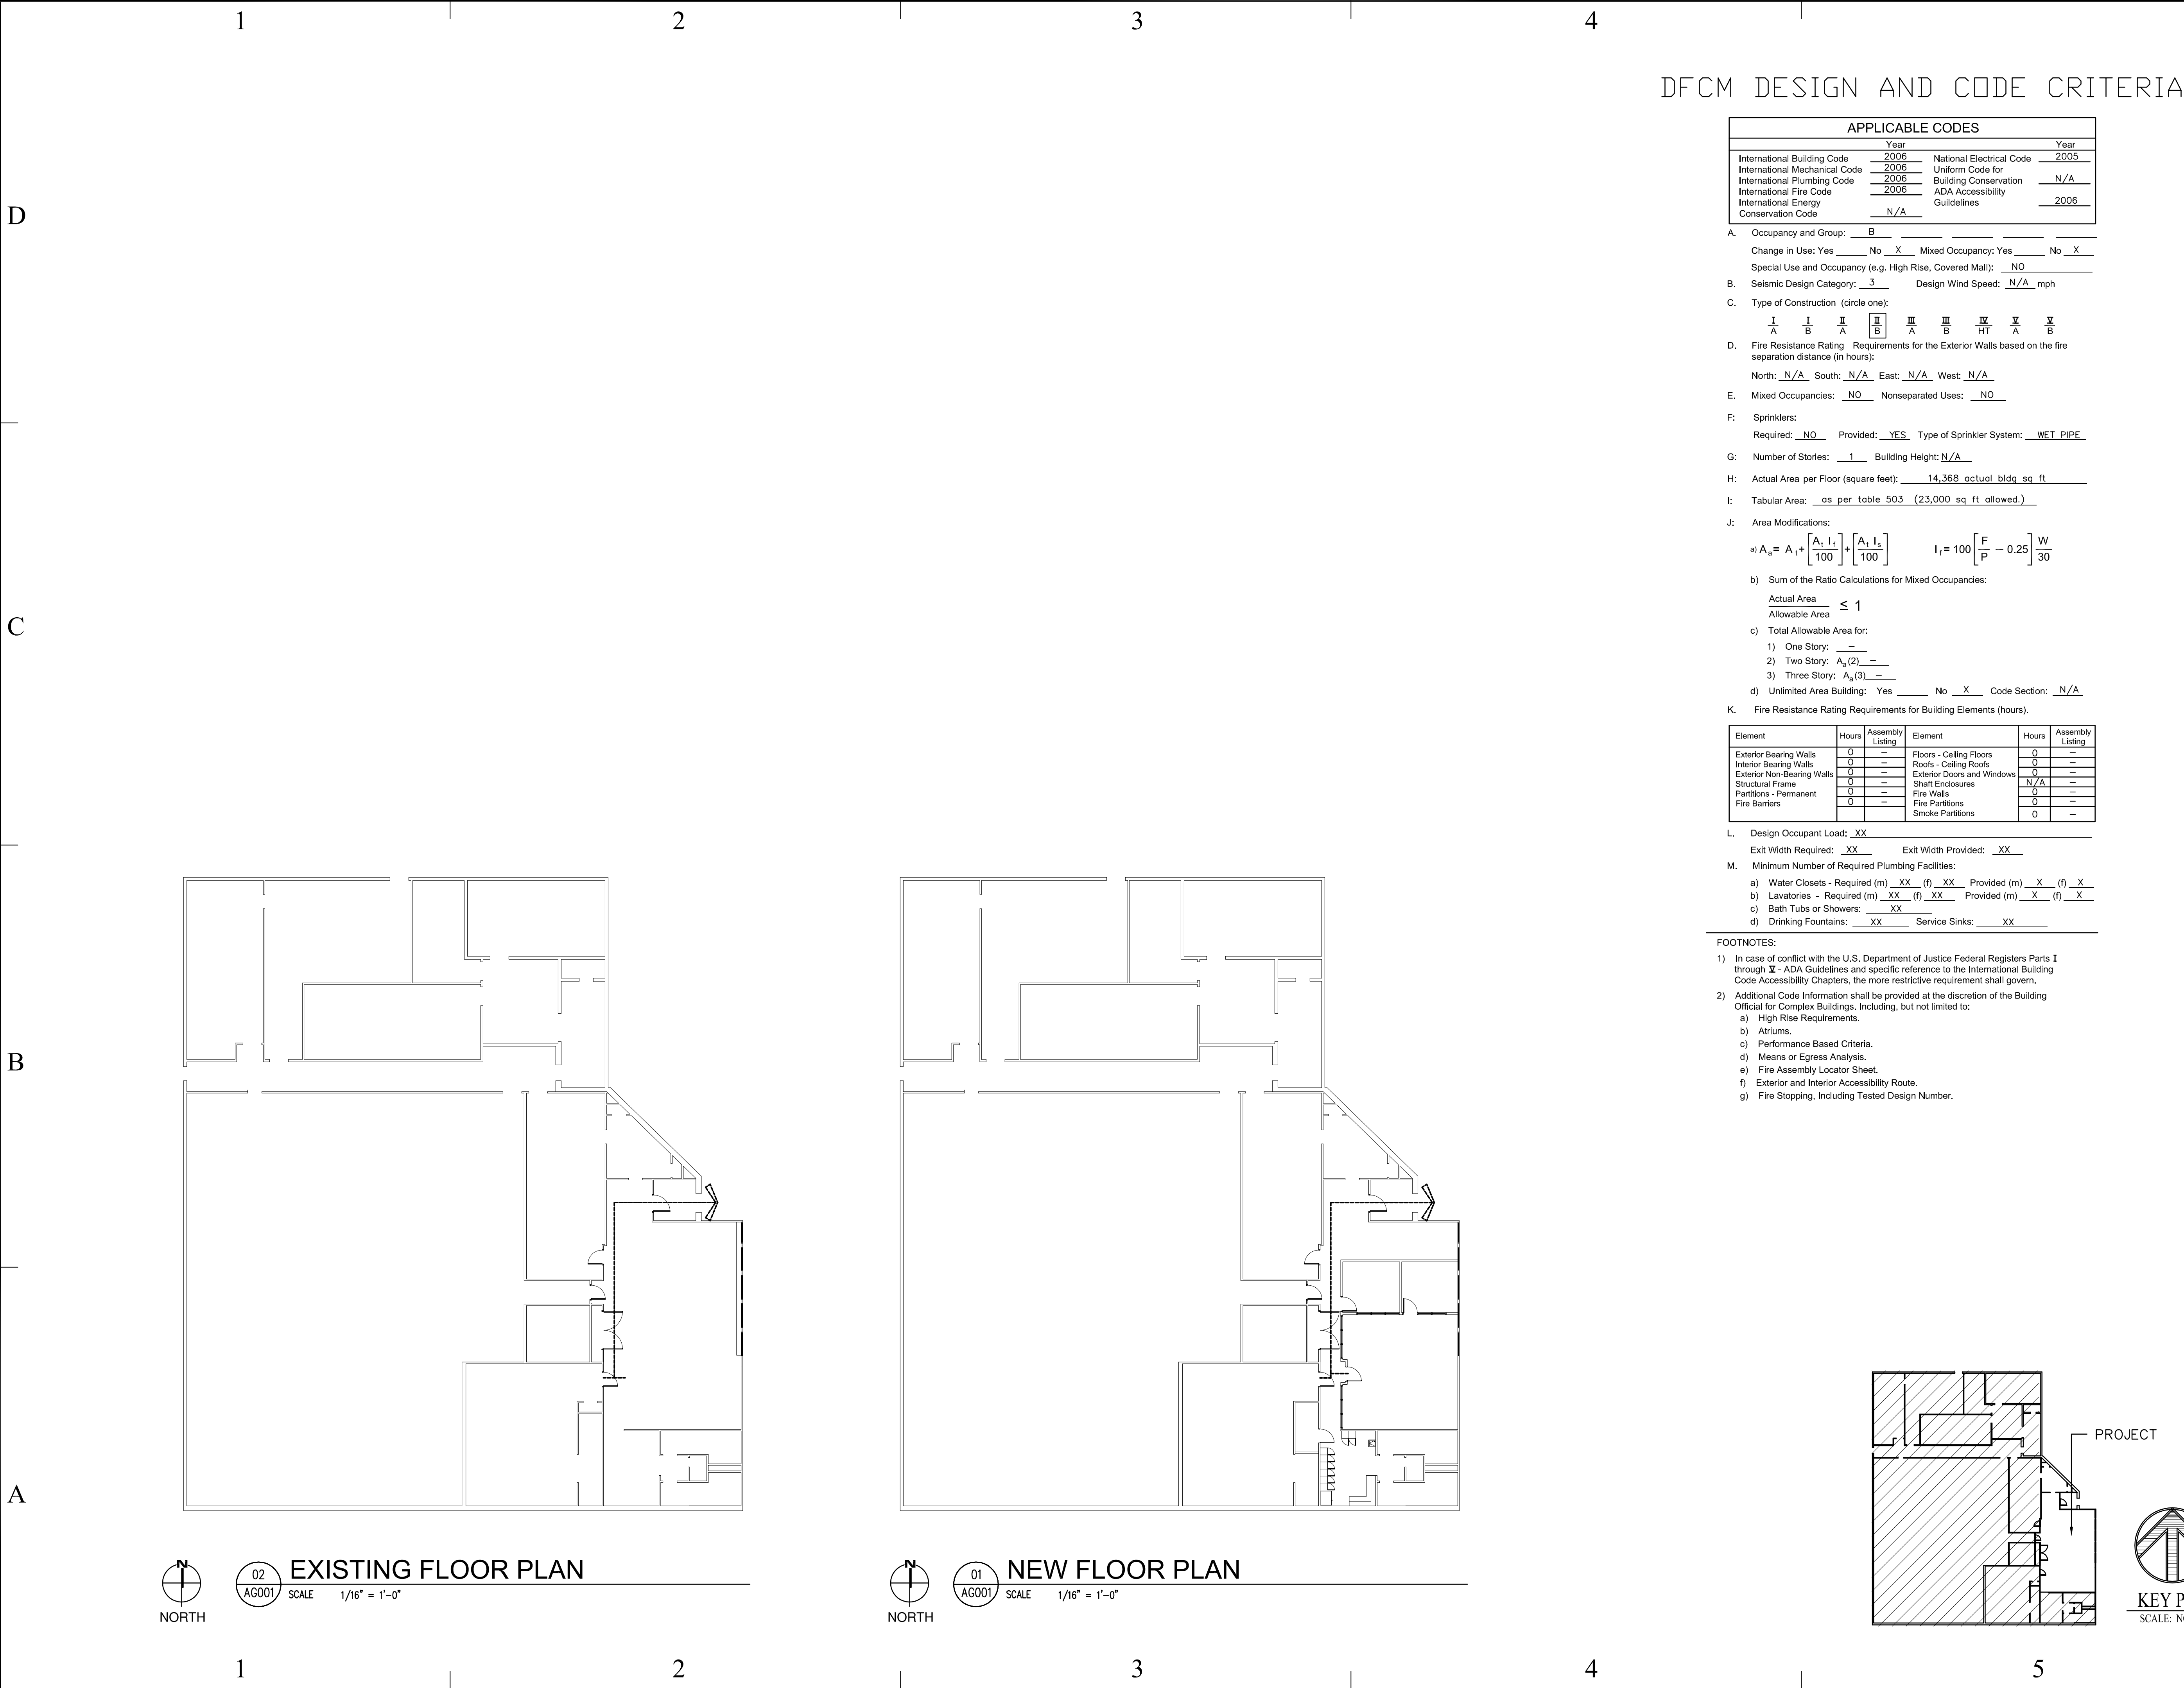


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b) Sum of the Ratio Calculations for Mixed Occupancies:
 $\frac{\text{Actual Area}}{\text{Allowable Area}} \leq 1$
c) Total Allowable Area for:
1) One Story: —
2) Two Story: $A_2(2)$ —
3) Three Story: $A_3(3)$ —
d) Unlimited Area Building: Yes — No X Code Section: N/A
- K. Fire Resistance Rating Requirements for Building Elements (hours).
- | Element | Hours | Assembly Listing | Element | Hours | Assembly Listing |
|----------------------------|-------|------------------|----------------------------|-------|------------------|
| Exterior Bearing Walls | 0 | — | Floors - Ceiling Floors | 0 | — |
| Interior Bearing Walls | 0 | — | Roofs - Ceiling Roofs | 0 | — |
| Exterior Non-Bearing Walls | 0 | — | Exterior Doors and Windows | 0 | — |
| Structural Frame | 0 | — | Shaft Enclosures | N/A | — |
| Partitions - Permanent | 0 | — | Fire Walls | 0 | — |
| Fire Barriers | 0 | — | Fire Partitions | 0 | — |
| | | | Smoke Partitions | 0 | — |
- L. Design Occupant Load: XX
Exit Width Required: XX Exit Width Provided: XX
- M. Minimum Number of Required Plumbing Facilities:
a) Water Closets - Required (m) XX (f) XX Provided (m) X (f) X
b) Lavatories - Required (m) XX (f) XX Provided (m) X (f) X
c) Bath Tubs or Showers: XX
d) Drinking Fountains: XX Service Sinks: XX

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 - Performance Based Criteria.
 - Means or Egress Analysis.
 - Fire Assembly Locator Sheet.
 - Exterior and Interior Accessibility Route.
 - Fire Stopping, Including Tested Design Number.



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ARCHITECTURE PLANNING DESIGN

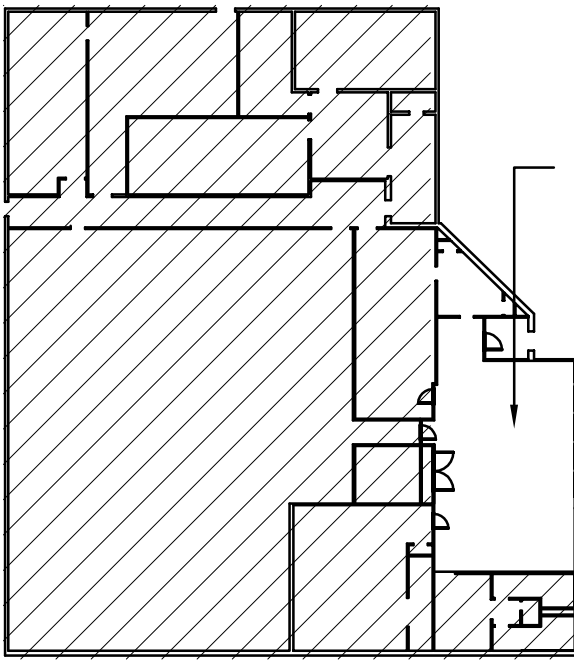PROJECT NAME & ADDRESS


**DEPARTMENT OF
SAFETY
RICHFIELD ITS UHP
DISPATCH
MODIFICATION**

DFCM No. 06298550

Richfield, Utah 84701


MARK	DATE	REVISION

PROJECT MANAGER:
WP
DRAWN BY:
STAFF
CHECKED BY:
SLW
DATE:
01/15/08
WHW JOB NO.:
06054

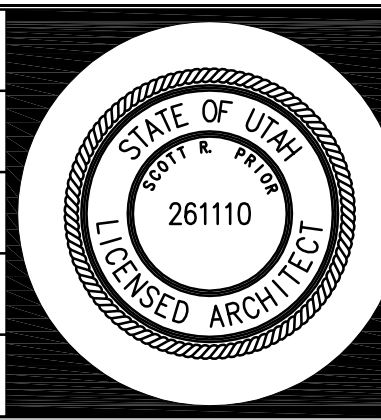

SHEET TITLE
**ARCHITECTURAL
GENERAL
INFORMATION**

SHEET NO. **A-G001**

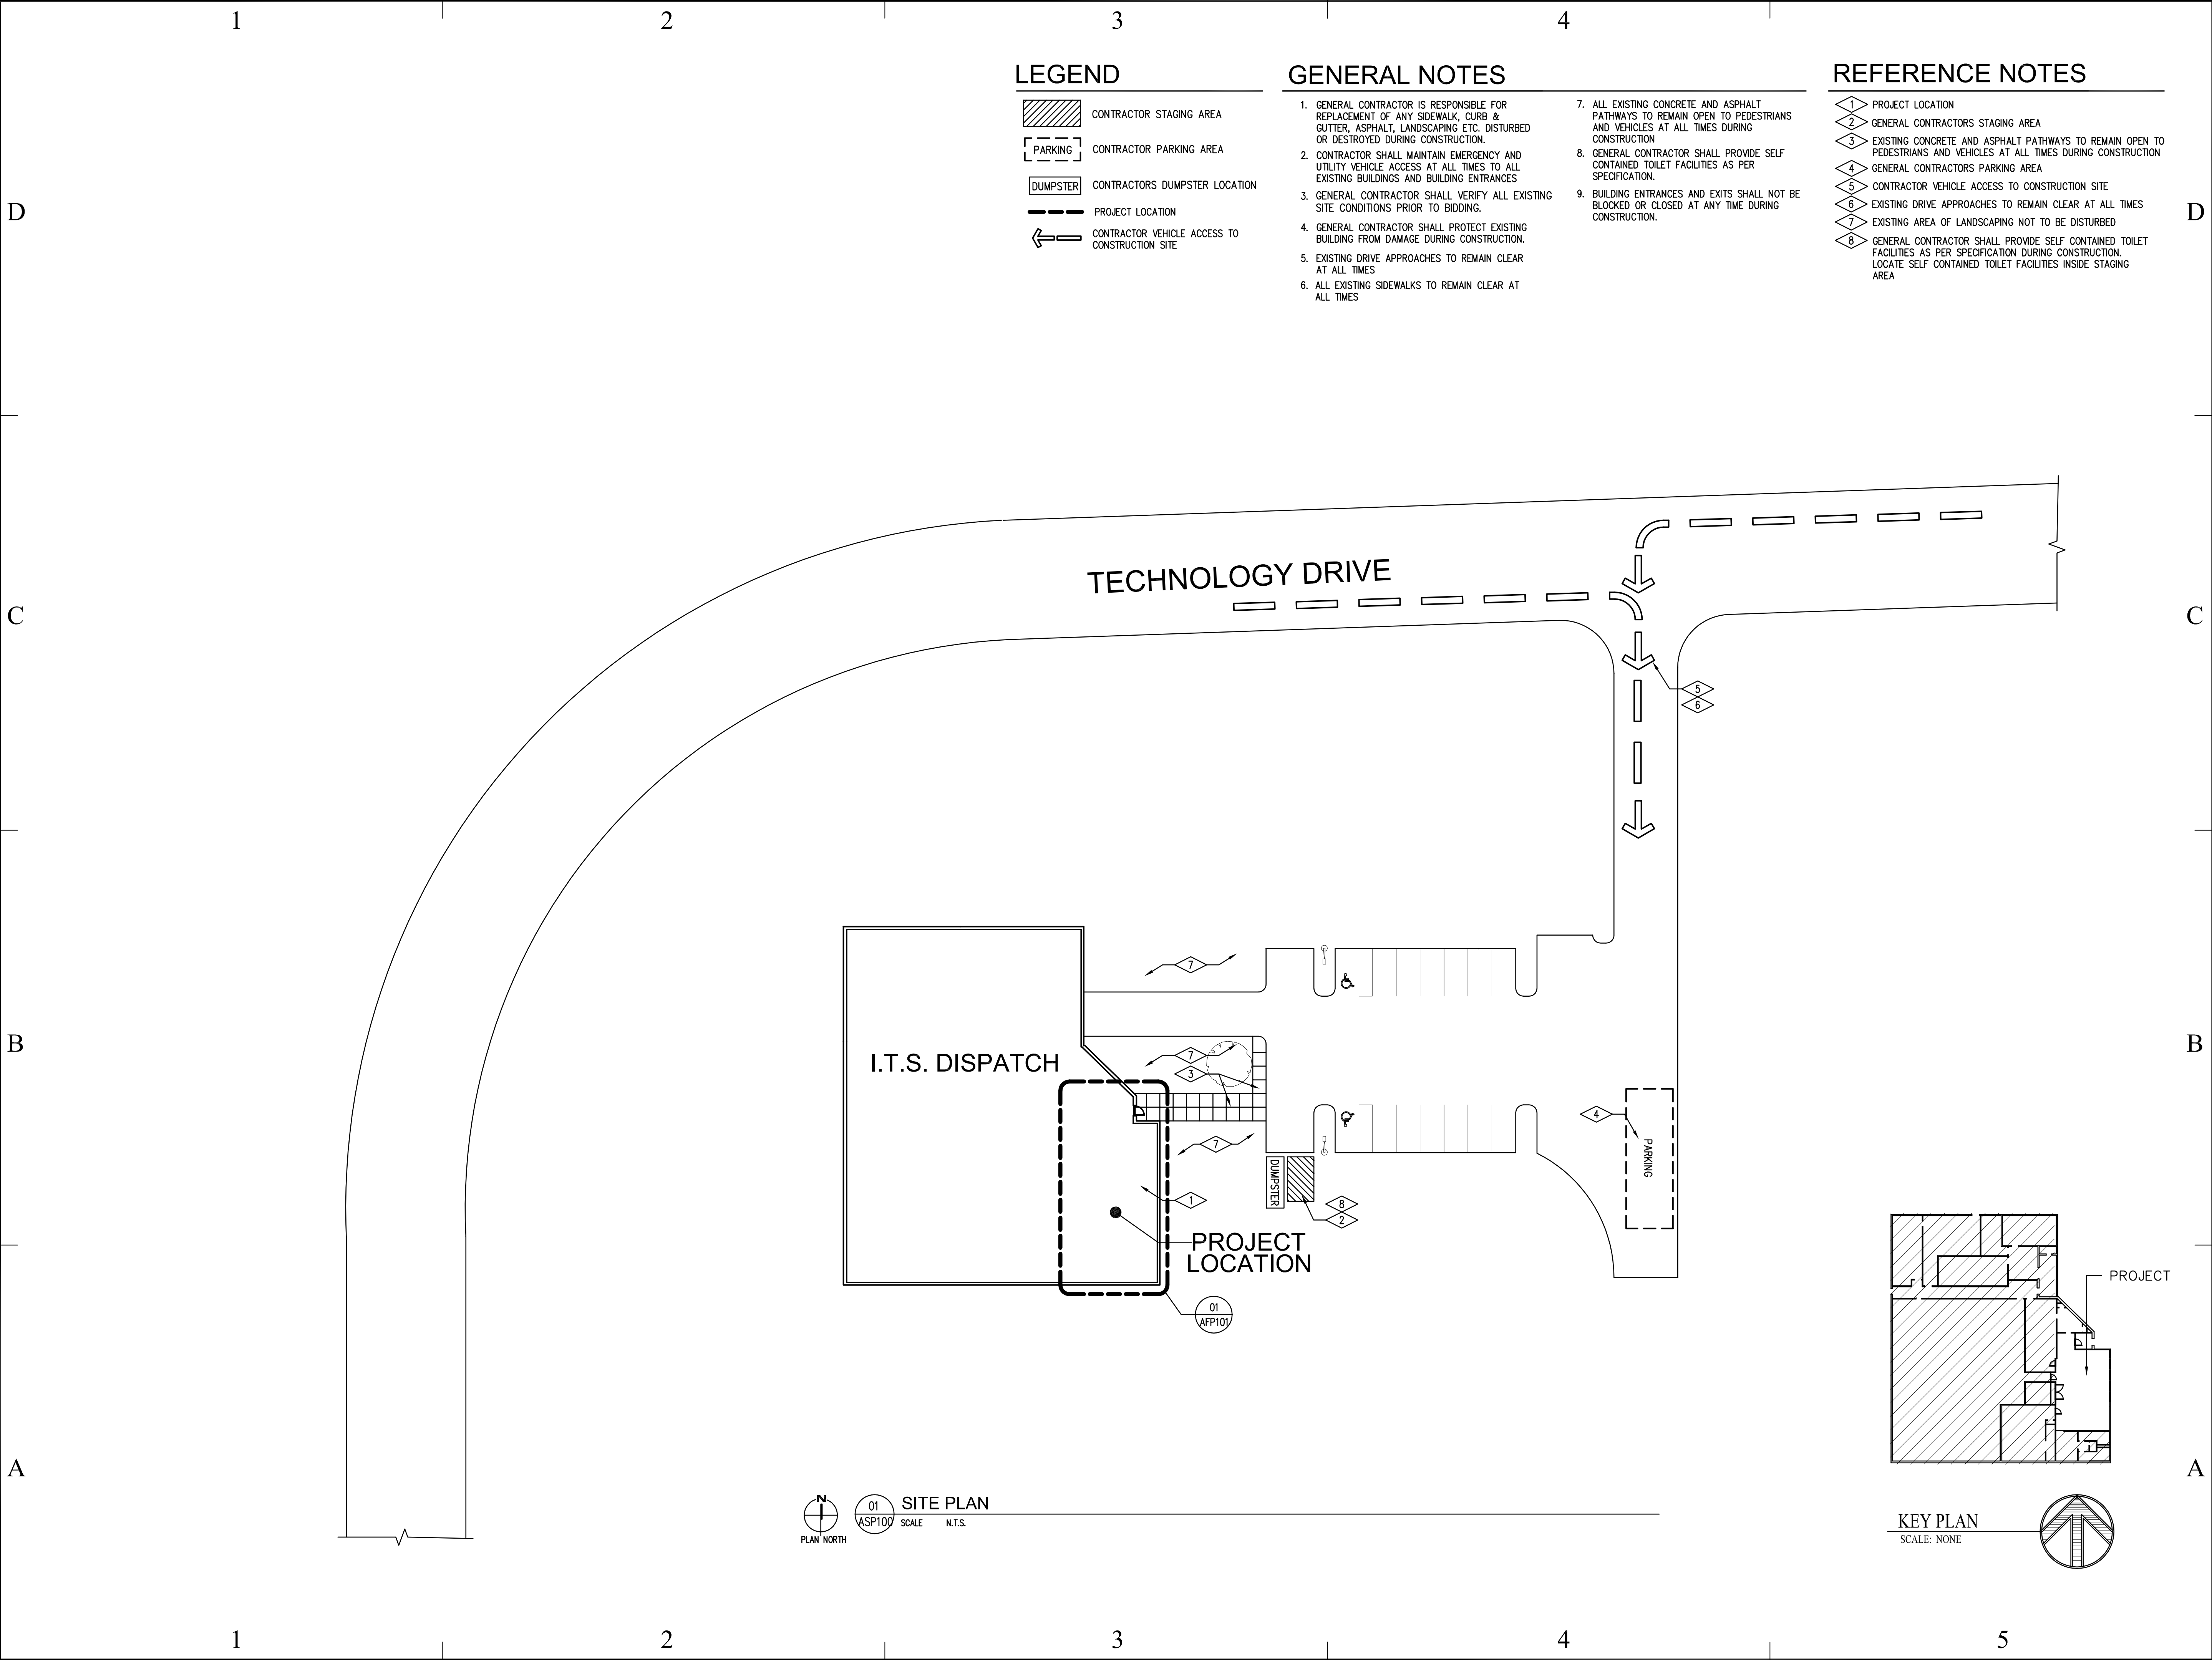

State of Utah
Department of Administrative Services

DFCM

Division of Facilities
Construction & Management
4110 State Office Building
Salt Lake City, Utah 84114
Phone: (801) 538 - 3018
Fax: (801) 538 - 3267

Internet: <http://www.dfcm.state.ut.us>

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RICHFIELD ITS UHP
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DFCM No. 06298550

Richfield, Utah 84701

MARK	DATE	REVISION

PROJECT MANAGER:
WP

DRAWN BY:
STAFF

CHECKED BY:
SLW

DATE:
01/22/08

WHW JOB NO.:
06054

SHEET TITLE

STATE OF UTAH
SEAL & TITLE
261110
LICENSED ARCHITECT

SITE PLAN

SHEET NO. A-SP101

1

2

3

4

REFERENCE NOTES


1 NOTE.

GENERAL NOTES

1. NOTE

LEGEND

- ⊗ E EXISTING EXIT SIGN, TO BE REMOVED AND RETURNED TO OWNER.
- EXISTING 2x4 FLUORESCENT LAY-IN LIGHT FIXTURE TO BE REMOVED.
- ⊗ EXISTING SUPPLY AIR DIFFUSER SEE MECHANICAL DRAWINGS FOR NEW DIFFUSERS LOCATIONS
- ⊗ EXISTING RETURN AIR DIFFUSER SEE MECHANICAL DRAWINGS FOR NEW DIFFUSER LOCATIONS
- ⊗ EXISTING MOTION SENSOR TO BE REMOVED AND REINSTALLED AS PER ELECTRICAL DRAWINGS.
- ⊗ EXISTING FIRE ALARM STROBE LIGHT LOCATION. PROVIDE NEW AS PER ELECTRICAL DRAWINGS.
- FS EXISTING FIRE SPRINKLER HEAD PROVIDE NEW FIRE SPRINKLER HEAD LOCATIONS AS NEEDED PER MECHANICAL AND PLUMBING PERFORMANCE SPECIFICATION REQUIREMENTS IN AREAS OF CONSTRUCTION
- HATCH PATTERN INDICATED AREA OF EXISTING LAY-IN CEILING TILE, CEILING GRID SYSTEM, LIGHT FIXTURES, MECHANICAL DIFFUSERS, AND ALL OTHER CEILING ELEMENTS TO BE REMOVED.

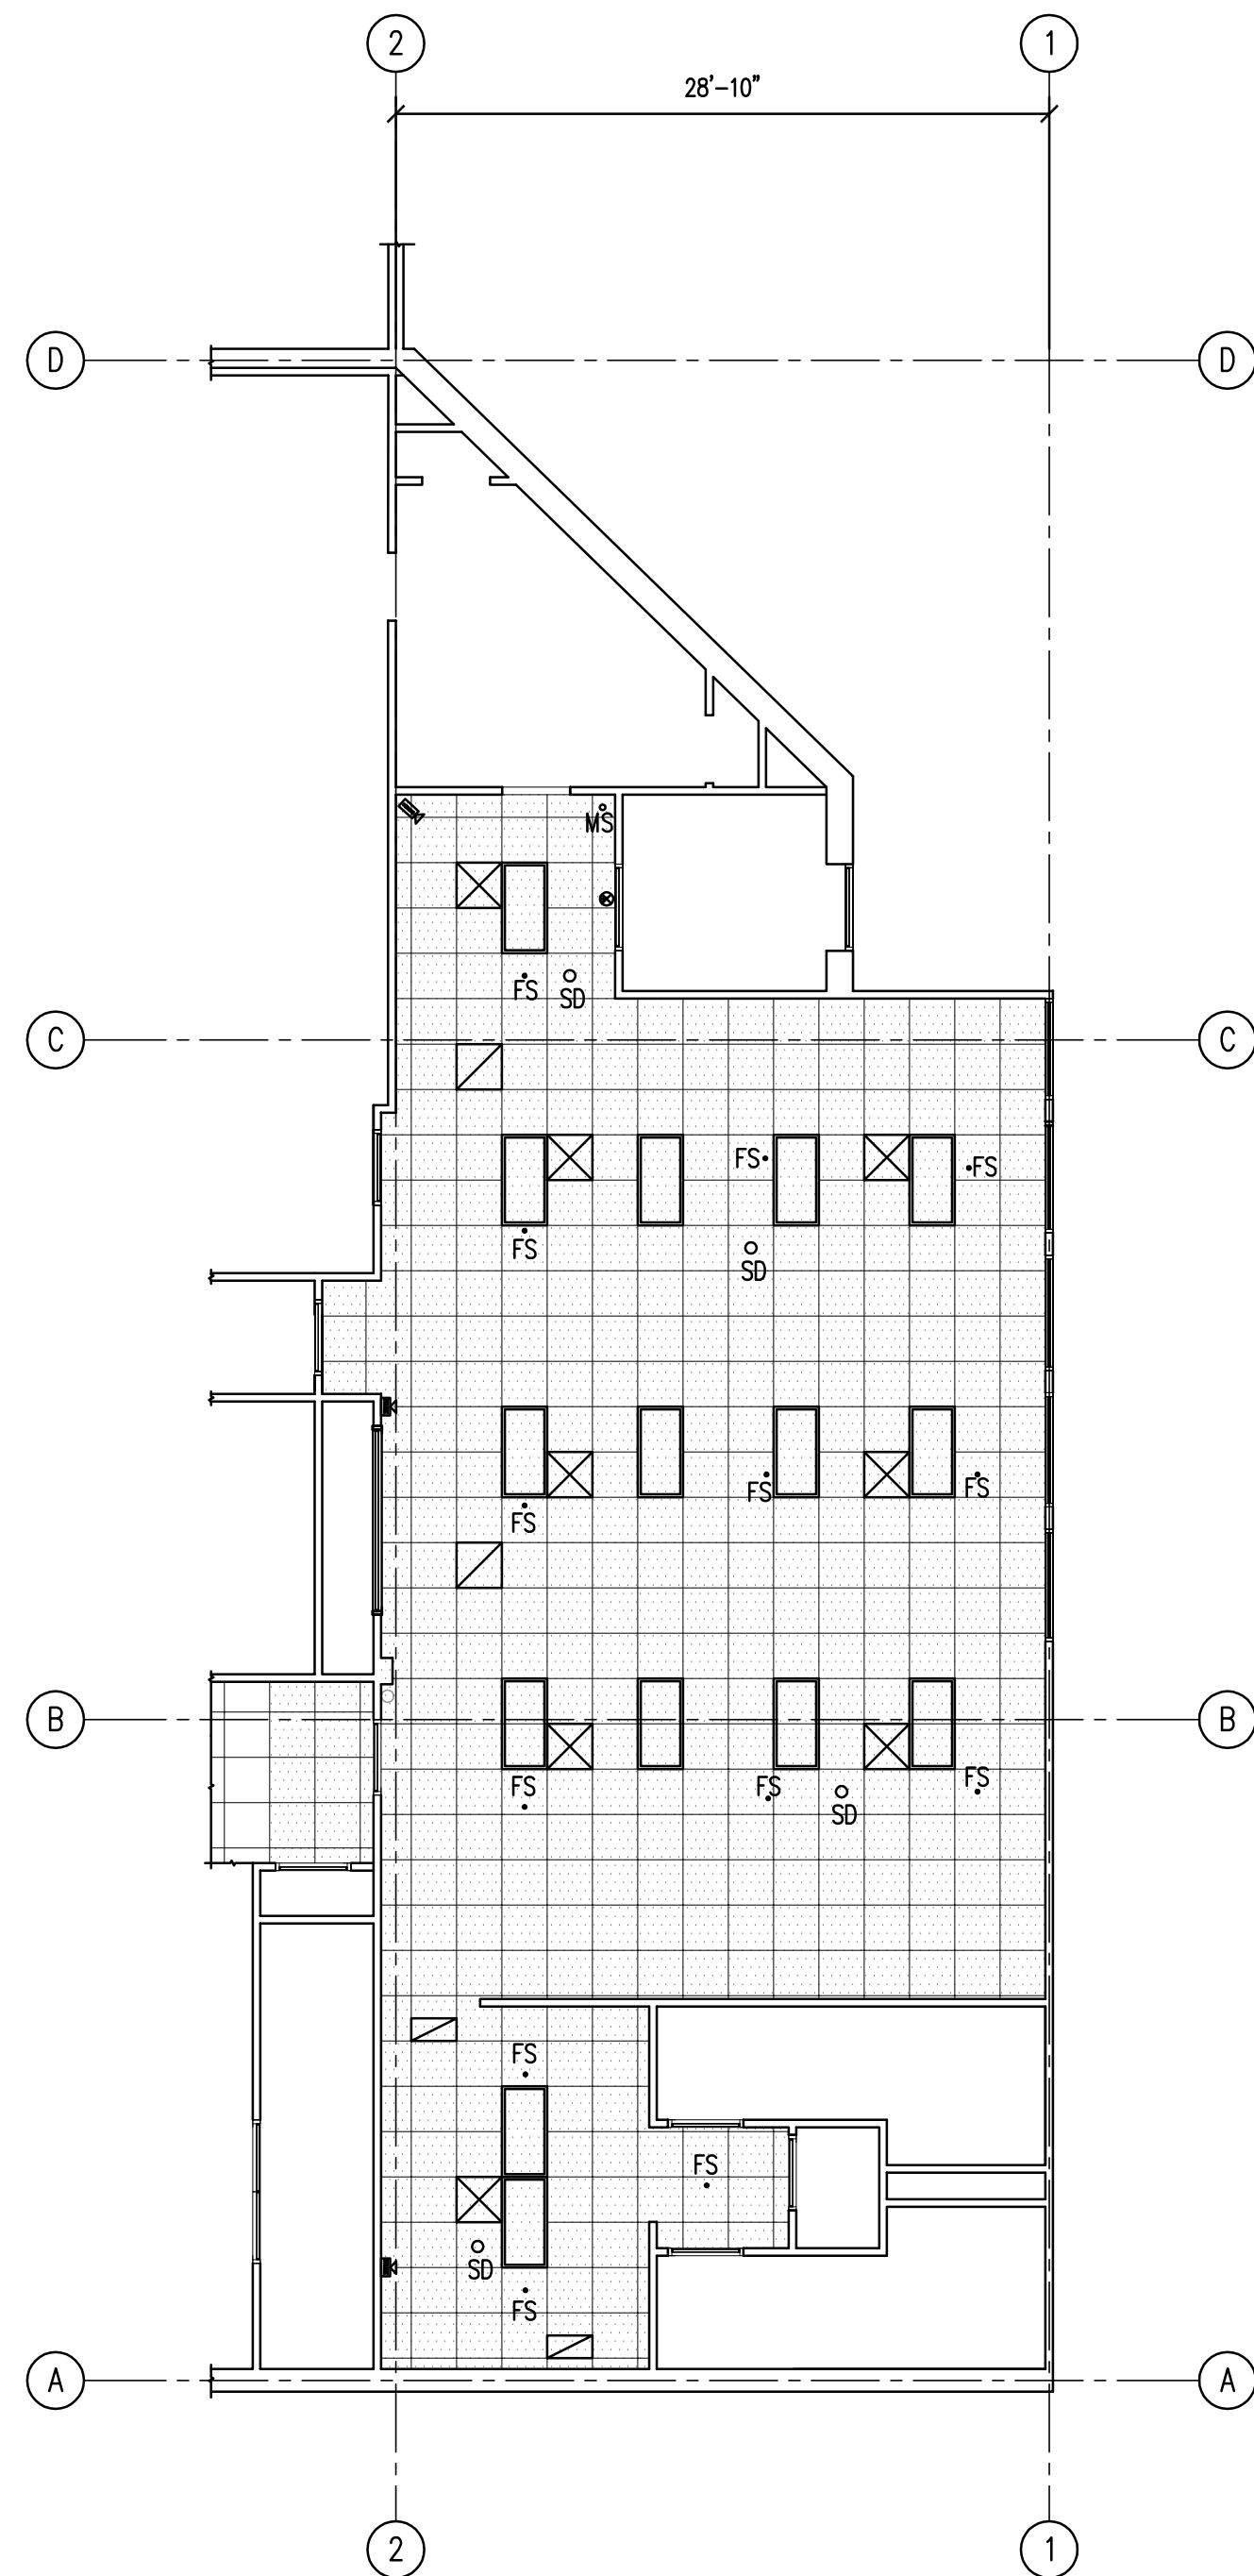02
ADP101

SCALE 1/8" = 1'-0"

DEMOLITION CEILING PLAN


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01
ADP101

SCALE 1/8" = 1'-0"

DEMOLITION FLOOR PLAN

01
ADP101

SCALE 1/8" = 1'-0"

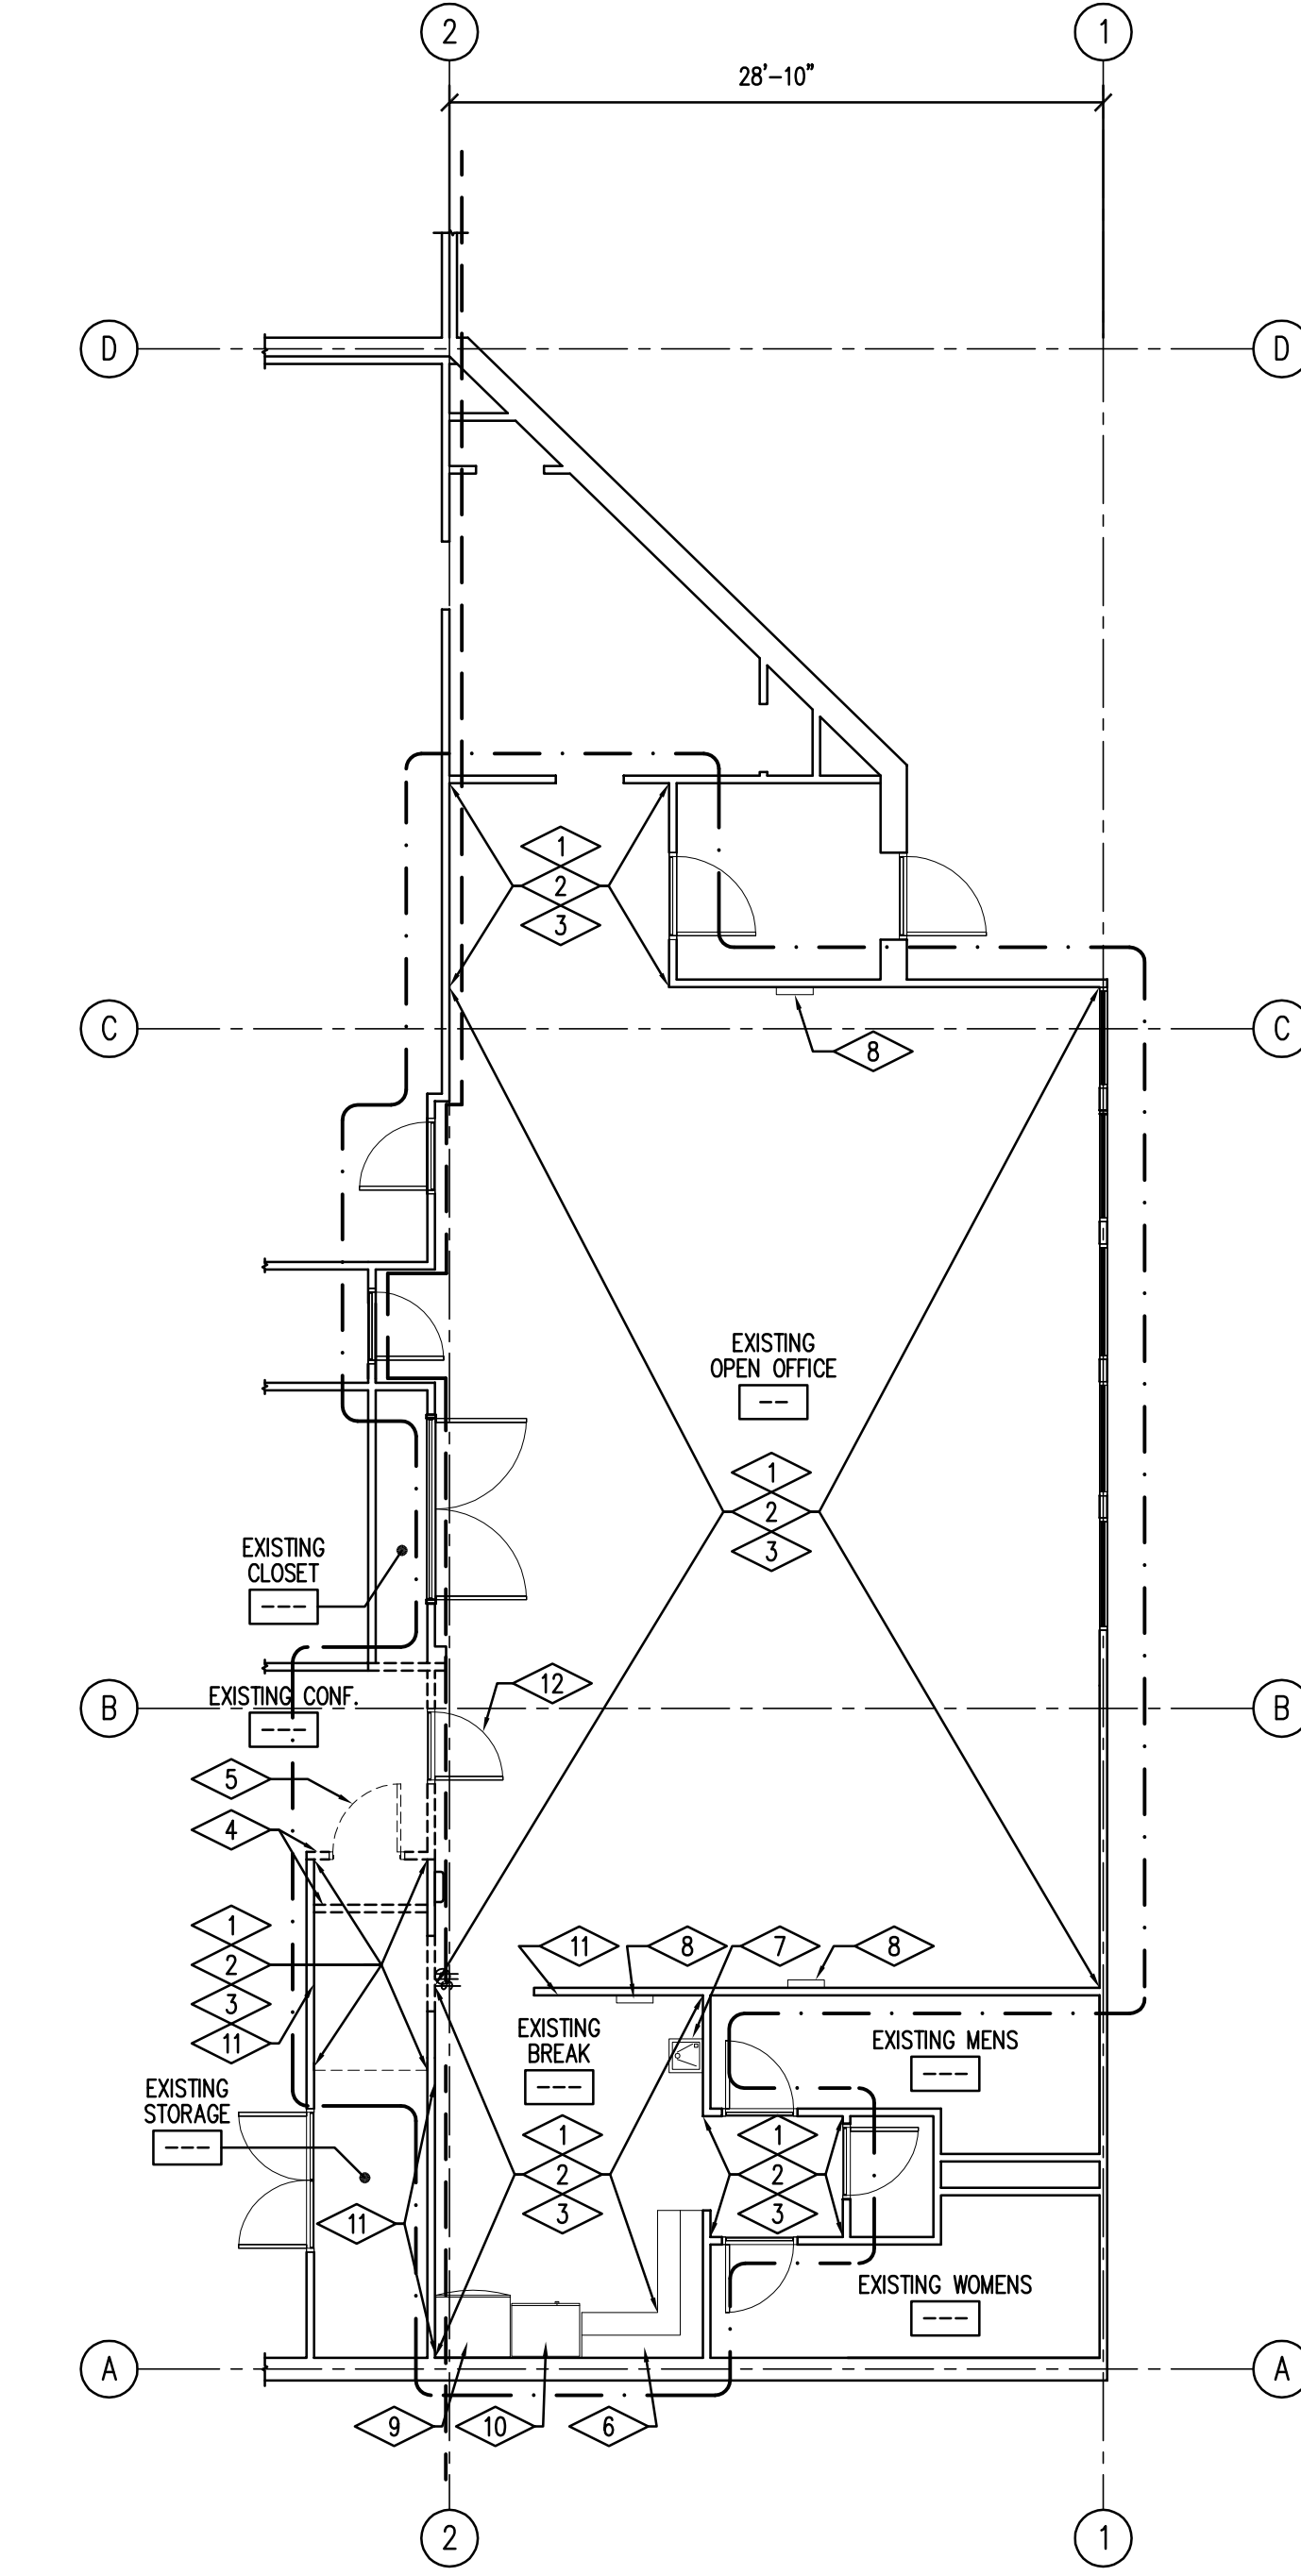DEMOLITION FLOOR PLAN

4

REFERENCE NOTES




- 1 AT WALLS THAT ARE SHOWN TO REMAIN, GENERAL CONTRACTOR SHALL REMOVE EXISTING RUBBER BASE AND ASSOCIATED ADHESIVE. GENERAL CONTRACTOR SHALL PROVIDE NEW RUBBER BASE AT THESE LOCATIONS AS PER SPECIFICATION.
- 2 EXISTING CARPET TO BE REMOVED. GENERAL CONTRACTOR TO PROVIDE NEW CARPET AS PER DRAWINGS AND SPECIFICATIONS.
- 3 AT EXISTING WALL THAT ARE TO REMAIN GENERAL CONTRACTOR SHALL REVIEW ELECTRICAL DRAWINGS FOR OUTLETS TO BE REMOVE AND NEW ELECTRICAL, DATA, PHONE ETC. LOCATIONS.
- 4 EXISTING GYPSUM BOARD WALLS TO BE REMOVED
- 5 EXISTING DOOR AND FRAME TO BE REMOVED
- 6 EXISTING CASEWORK TO REMAIN UNDISTURBED AND PROTECTED.
- 7 EXISTING ELECTRIC WATER COOLER TO REMAIN UNDISTURBED AND PROTECTED.
- 8 EXISTING WALL MOUNTED CLOCKS TO BE REMOVED. SEE ELECTRICAL DRAWINGS FOR NEW WALL MOUNTED CLOCK LOCATIONS.
- 9 EXISTING COKE MACHINE TO BE REMOVED AND RELOCATED AS PER OWNERS DIRECTIONS.
- 10 EXISTING REFRIGERATOR TO BE REMOVED AND STORED DURING CONSTRUCTION. RELOCATE AS PER NEW FLOOR PLAN.
- 11 GENERAL CONTRACTOR SHALL REMOVE EXISTING LAYER OF 3/4" GYPSUM BOARD AT LOCATIONS WHERE NEW LOCKERS AND CABINETS ARE TO BE LOCATED. GENERAL CONTRACTOR SHALL PROVIDE WOOD BLOCKING AS NEEDED FOR ADEQUATE SUPPORT OF NEW CASEWORK. PROVIDE NEW 3/4" GYPSUM BOARD AND FINISH AS REQUIRED TO MAINTAIN UL 1 HOUR FIRE RATING.
- 12 EXISTING FIRE RATED DOOR, FRAME AND HARDWARE TO BE REMOVED AND RELOCATED AS PER NEW FLOOR PLAN.

GENERAL NOTES

1. GENERAL CONTRACTOR SHALL REPLACE AND REPAIR ALL CONCRETE FLOORING DAMAGED DURING THE DEMOLITION AND CONSTRUCTION.
2. SEE ELECTRICAL & MECHANICAL DEMOLITION DRAWINGS & NOTES.
3. IN AREAS OF CONSTRUCTION WHERE WALLS ARE TO REMAIN, GENERAL CONTRACTOR SHALL PATCH AND REPAIR WALL SURFACE TO RECEIVE NEW FINISH AS PER FINISH SCHEDULE.
4. GENERAL CONTRACTOR SHALL PROVIDE A 6 MIL POLYETHYLENE DUST BARRIER FROM FLOOR TO METAL DECK ABOVE AND SHALL BE SEALED AIR TIGHT IN ALL PHASED AREA OF CONSTRUCTION

LEGEND

- ⌋ DASHED DOOR LINES INDICATE EXISTING DOOR AND FRAME TO BE REMOVED
- DASHED LINES INDICATE EXISTING WALLS TO BE REMOVED.
- CONTRACT LIMIT LINE
- 1 HOUR FIRE WALL LOCATION

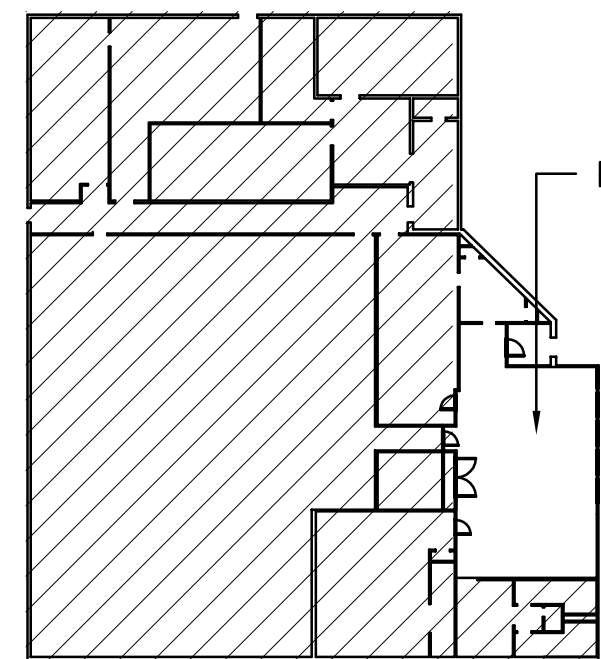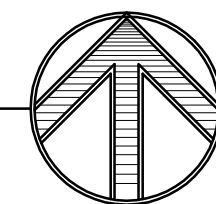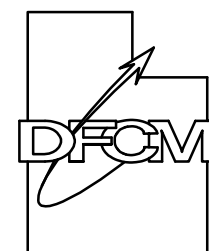KEY PLAN
SCALE: NONEState of Utah
Department of Administrative ServicesDivision of Facilities
Construction & Management
4110 State Office Building
Salt Lake City, Utah 84114
Phone: (801) 538 - 3018
Fax: (801) 538 - 3267Internet: <http://www.dfcm.state.ut.us>

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Salt Lake City, Utah 84105

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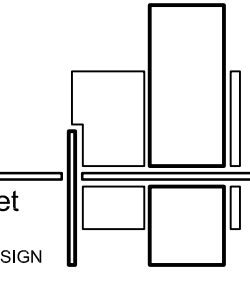
F: 801.485.4640

e-mail parchitects@comcast.net

ARCHITECTURE

PLANNING

DESIGN



PROJECT NAME & ADDRESS

**DEPARTMENT OF
SAFETY
RICHFIELD ITS UHP
DISPATCH
MODIFICATION****DFCM No. 06298550**

Richfield, Utah 84701

MARK	DATE	REVISION

PROJECT MANAGER:

WP

DRAWN BY:

STAFF

CHECKED BY:

SLW

DATE:

01/16/08


WHW JOB NO.:

06054

SHEET TITLE

**DEMOLITION FLOOR
AND
CEILING PLAN**

SHEET NO.

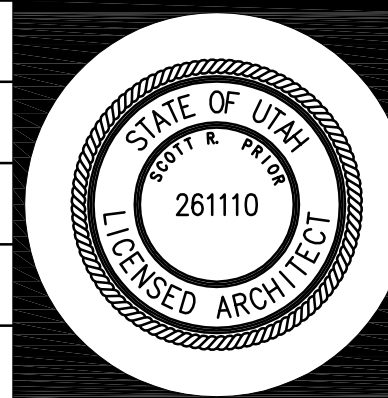A-DP101

1

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REFERENCE NOTES


- 1 EXISTING CEILING SYSTEM AT EXISTING CONFERENCE ROOM LOCATION TO BE REPAIRED TO A "LIKE NEW" FINISH

CEILING LEGEND

- 101 ROOM NUMBER
9'-0" CEILING HEIGHT
C1 CEILING TYPE
NEW 2x4 FLUORESCENT LAY-IN LIGHT FIXTURE. SEE ELECTRICAL DRAWINGS.
NEW EXIT SIGN, SEE ELECTRICAL DRAWINGS.
NEW HANGING DIRECT/INDIRECT FLUORESCENT LIGHT FIXTURE WITH ADJUSTABLE LIGHTING. SEE ELECTRICAL DRAWINGS.
SUPPLY AIR DIFFUSER CONTRACTOR TO VERIFY LOCATION WITH MECHANICAL DRAWINGS
RETURN AIR DIFFUSER GENERAL CONTRACTOR TO VERIFY WITH MECHANICAL DRAWINGS

GENERAL NOTES

1. REFER TO FINISH SCHEDULE FOR ADDITIONAL FINISH NOTES.
2. NEW SUSPENDED CEILING GRIDS SHALL BE CENTERED IN SPACES AS SHOWN ON REFLECTED CEILING PLANS, UNLESS SHOWN OTHERWISE.
*3. GENERAL CONTRACTOR SHALL NOTE THAT BOTTOM OF METAL DECK IS 5'-0" ABOVE FINISHED CEILING HEIGHT AS NOTED ON REFLECTED CEILING PLAN.

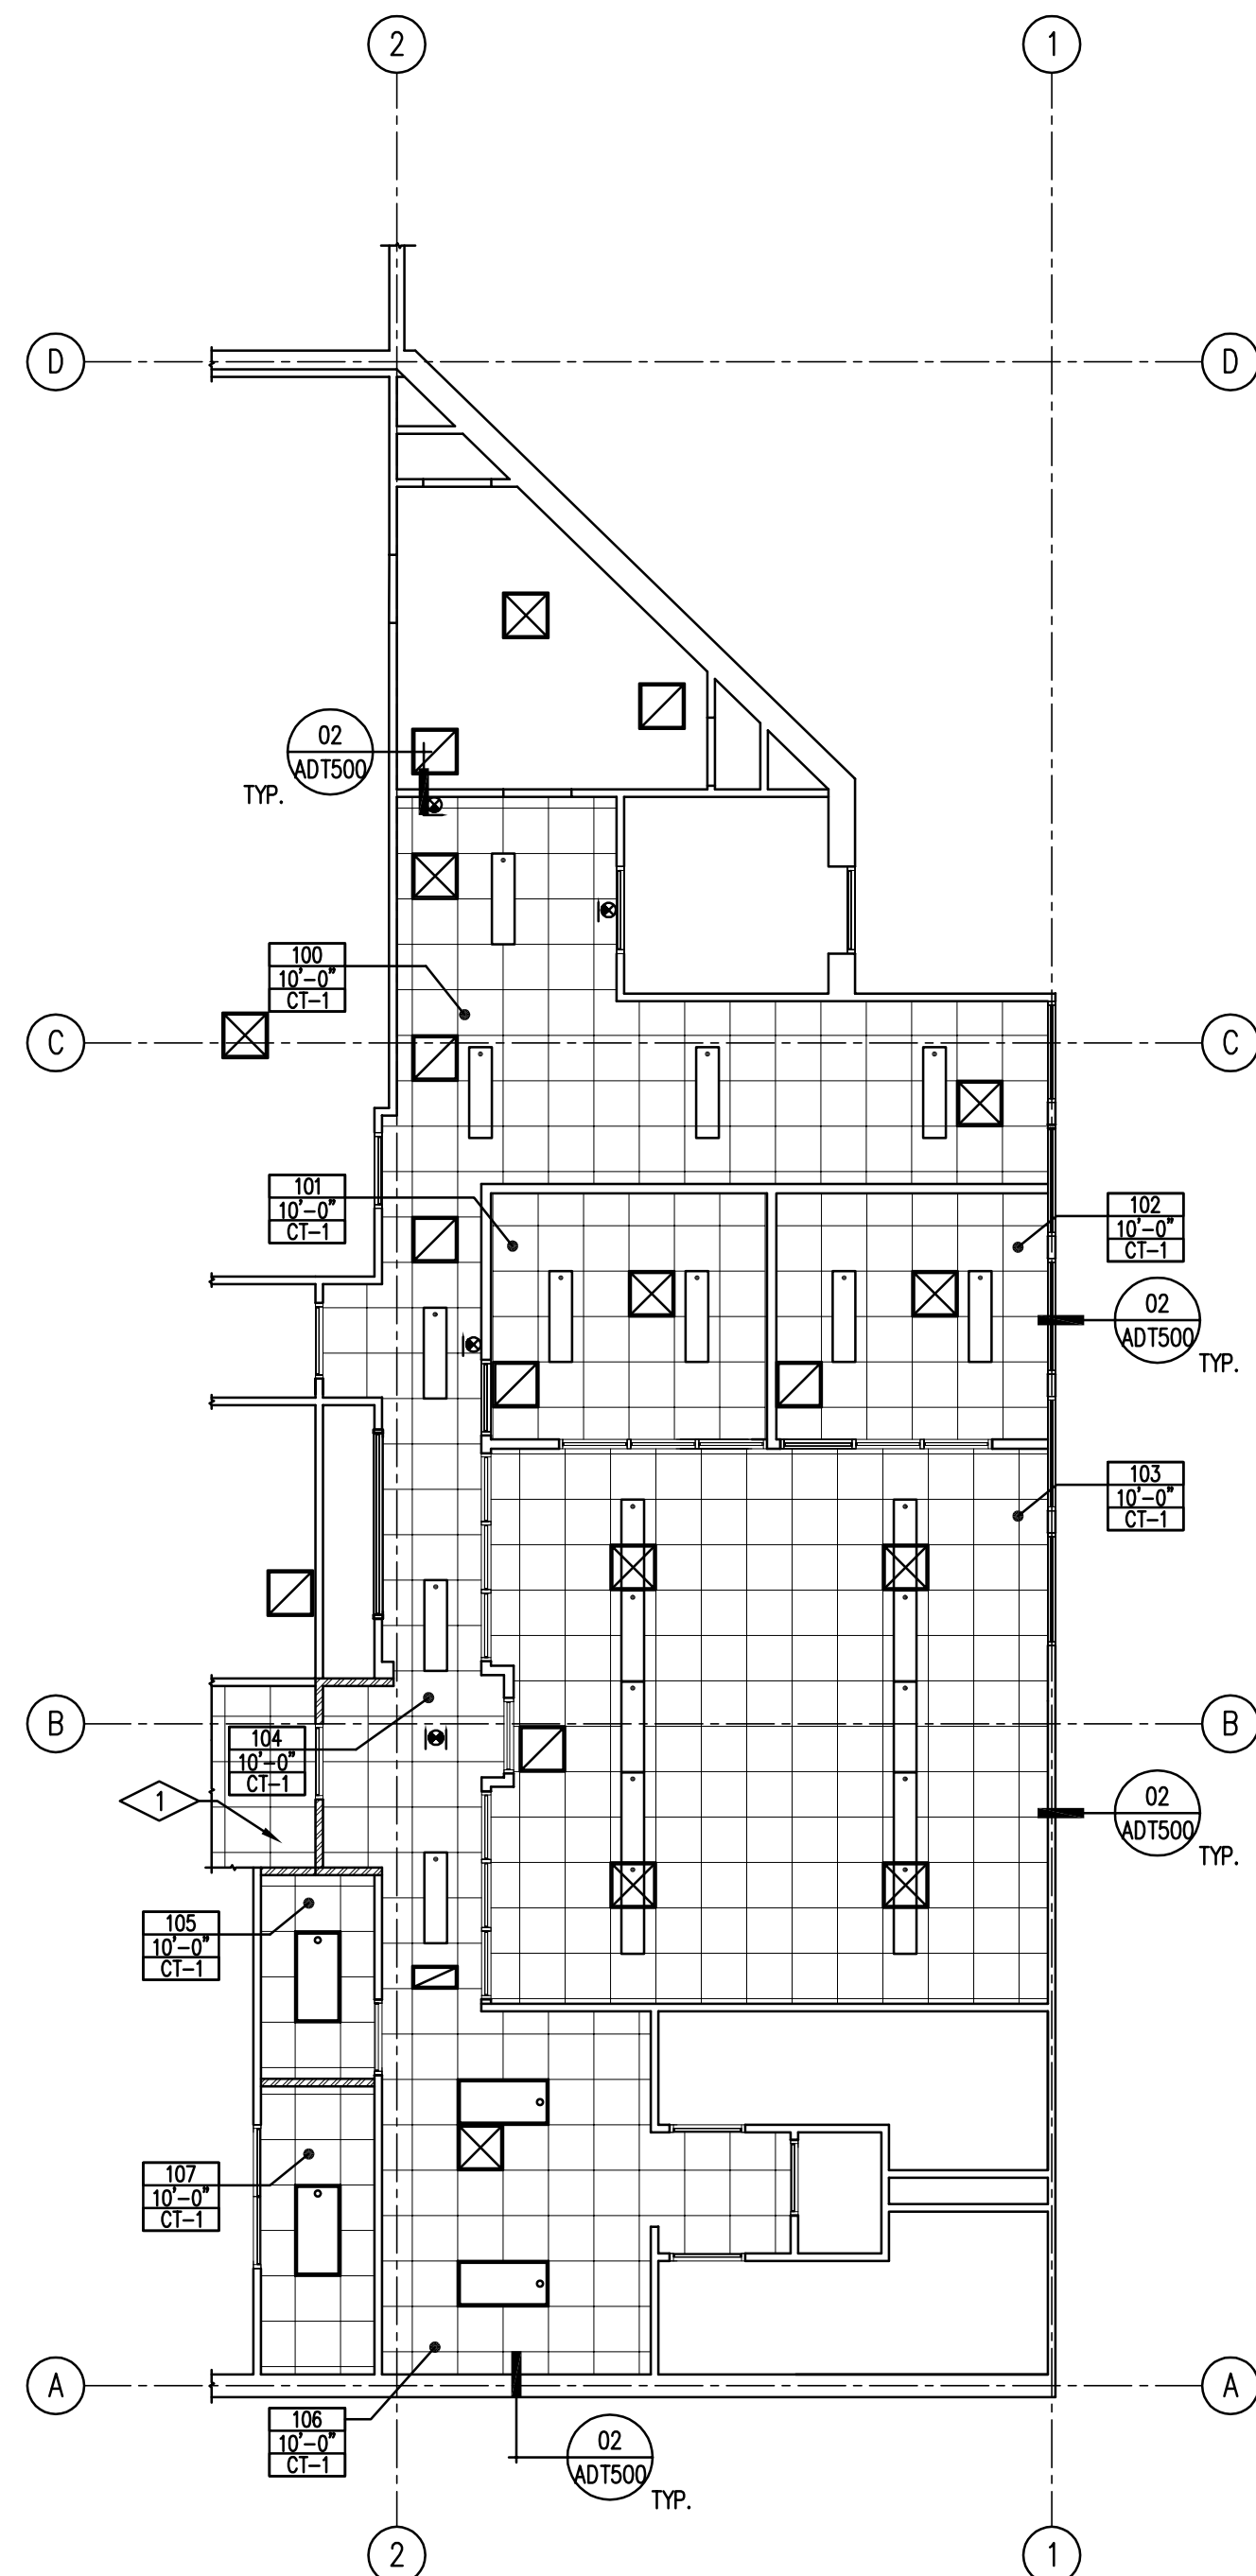02
AFP101NEW REFLECTED CEILING PLAN
SCALE 1/8\"/>

1

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3

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REFERENCE NOTES


- 1 GENERAL CONTRACTOR SHALL PRIME, PAINT AND PROVIDE NEW RUBBER BASE FOR NEW WALL IN EXISTING CONFERENCE ROOM 100
2 NEW METAL LOCKERS, SEE INTERIOR ELEVATIONS AND SPECIFICATIONS
3 EXISTING BREAKROOM CASEWORK TO REMAIN UNDISTURBED. GENERAL CONTRACTOR SHALL PROVIDE NEW RUBBER BASE AT CASEWORK
4 EXISTING ELECTRICAL WATER COOLER TO REMAIN UNDISTURBED.
5 AT EXISTING 1 HOUR FIRE RATED WALL LOCATION WHERE GENERAL CONTRACTOR WILL BE CUTTING INTO WALL TO PROVIDE A NEW DOOR, THE GENERAL CONTRACTOR SHALL PATCH AND REPAIR THE EXISTING GYPSUM BOARD WALL TO MAINTAIN THE 1 HOUR RATED ASSEMBLY
6 EXISTING HOLLOW METAL DOORS AND FRAMES TO BE REPAINTED ON SIDE WHERE NEW CONSTRUCTION IS OCCURRING TO MATCH FINISHED PAINT AS SCHEDULED ON NEW HOLLOW METAL DOORS AND FRAMES.
7 PROPOSED LOCATION OF BUILDING SECURITY MONITOR. GENERAL CONTRACTOR SHALL VERIFY EXACT LOCATION WITH END USER. GENERAL CONTRACTOR SHALL PROVIDE ADDITIONAL WALL SUPPORT/BACKING AS NEEDED FOR MONITOR ATTACHMENT, SEE ELECTRICAL DRAWINGS.
8 PROPOSED LOCATION OF 52\"/>

FLOOR PLAN LEGEND


- 100A DOOR TAG, SEE DOOR SCHEDULE
RM. NAME ROOM TAG
WT-01 WALL TYPE, SEE WALL TYPES SHEET A
EXIST EXISTING DOOR TO REMAIN UNDISTURBED
NEW WALL LOCATIONS SEE WALL TYPES ON DRAWING A501
CONTRACT LIMIT LINE
WINDOW TAG
E.S.R.F.E. EXISTING SEMI-RECESSED FIRE EXTINGUISHER TO REMAIN UNDISTURBED.
1 HOUR FIRE WALL LOCATION
DASHED LINE AT WINDOWS INDICATES LOCATION OF 2\"/>

GENERAL NOTES

1. REFER TO FINISH SCHEDULE FOR ADDITIONAL FINISH NOTES.
2. SEE WALL TYPES FOR WALL ASSEMBLIES.
3. WHERE NEW WALLS TIE-IN TO EXISTING GYPSUM BOARD WALLS, GENERAL CONTRACTOR SHALL CREATE A "LIKE NEW" FINISH.
4. WHERE WALLS HAVE BEEN REMOVED THAT TIE INTO WALLS THAT ARE TO REMAIN, THE GENERAL CONTRACTOR SHALL PATCH, REPAIR, REPAINT, PROVIDE NEW RUBBER BASE AND FINISH WALLS TO A "LIKE NEW" FINISH.
5. THE GENERAL CONTRACTOR IS RESPONSIBLE TO PATCH, REPAIR AND REPAINT ALL EXISTING WALLS THAT WILL NEED TO BE CUT IN ORDER TO INSTALL ELECTRICAL CONDUITS AND BOXES AS SHOWN ON ELECTRICAL DRAWINGS.
6. IN EACH AREA/PHASE OF CONSTRUCTION, GENERAL CONTRACTOR SHALL PROVIDE A 6 MIL. POLYETHYLENE DUST BARRIER FROM FLOOR TO METAL DECK ABOVE.
7. WHERE WALLS HAVE BEEN REMOVED AND OPENINGS HAVE BEEN INFILLED, GENERAL CONTRACTOR SHALL PATCH AND REPAIR WALL AT LOCATIONS TO CREATE A "LIKE NEW" WALL READY FOR FINISH PAINT
*8. GENERAL CONTRACTOR SHALL NOTE THAT BOTTOM OF METAL DECK IS 5'-0" ABOVE FINISHED CEILING HEIGHT AS NOTED ON REFLECTED CEILING PLAN.

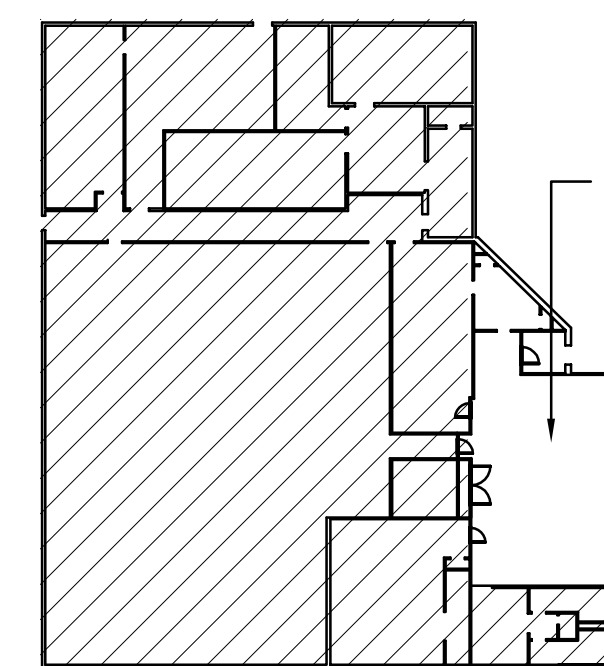KEY PLAN
SCALE: NONE

5

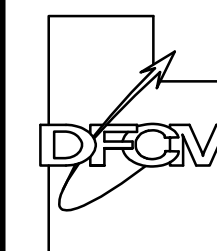State of Utah
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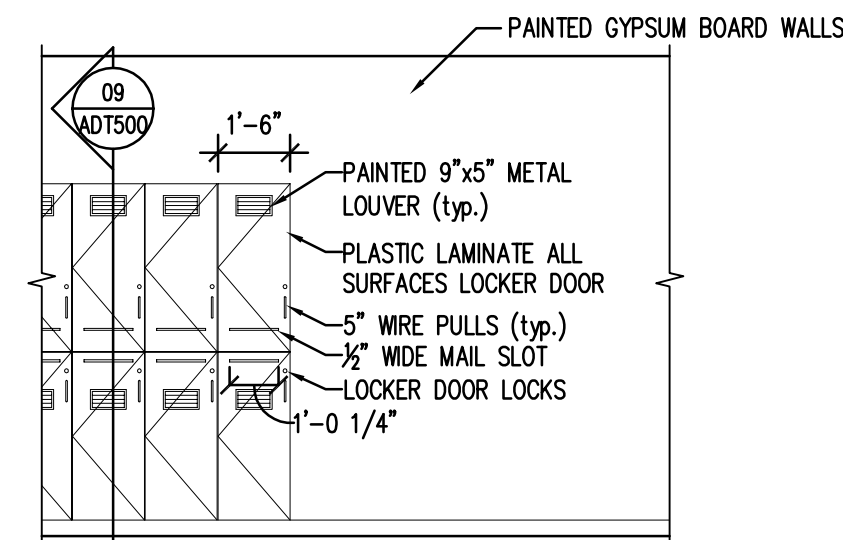
NEW FLOOR
AND
CEILING PLAN

SHEET NO. A-FP101

DOOR AND FRAME SCHEDULE																
DOOR	SINGLE PAIR	DOOR						FRAME						FIRE RATING DOOR & FRAME	NOTES	
		SIZE		DEPTH	TYPE	MATL	FINISH	DEPTH	TYPE	MATL	FINISH	DETAIL				
		WxH										HEAD	JAMB			THRSH
101A	S	3'-0" x 7'-0"	1 3/4"	B	HM	PAINT	6"	01	HM	PAINT	06/ADT500	06/ADT500	NONE	03	NONE	
102A	S	3'-0" x 7'-0"	1 3/4"	B	HM	PAINT	6"	02	HM	PAINT	06/ADT500	06/ADT500	NONE	03	NONE	
103A	S	3'-0" x 7'-0"	1 3/4"	B	HM	PAINT	6"	01	HM	PAINT	06/ADT500	06/ADT500	NONE	03	NONE	
105A	S	3'-0" x 7'-0"	1 3/4"	A	HM	PAINT	6"	01	HM	PAINT	06/ADT500	06/ADT500	NONE	01	45 MIN	

1. SEE REFERENCE NOTE #6 ON DRAWING AFP-101 THAT INDICATES LOCATION OF EXISTING HOLLOW METAL DOOR AND FRAMES TO BE REPAINTED ON THE SIDE WHERE NEW CONSTRUCTION AND PAINTING WILL OCURE.

GLAZING TYPES	
G-1	1" INSULATED, TEMPERED GLAZING, CLEAR
G-2	1" INSULATED GLAZING, CLEAR



01
ADT500


PAINTED GYPSUM BOARD WALLS

PLASTIC LAMINATE OVER $\frac{3}{4}$ " PLYWOOD SHELVES


RUBBER BASE, SEE SPECIFICATION

STORAGE ROOM 105

INTERIOR ELEVATION

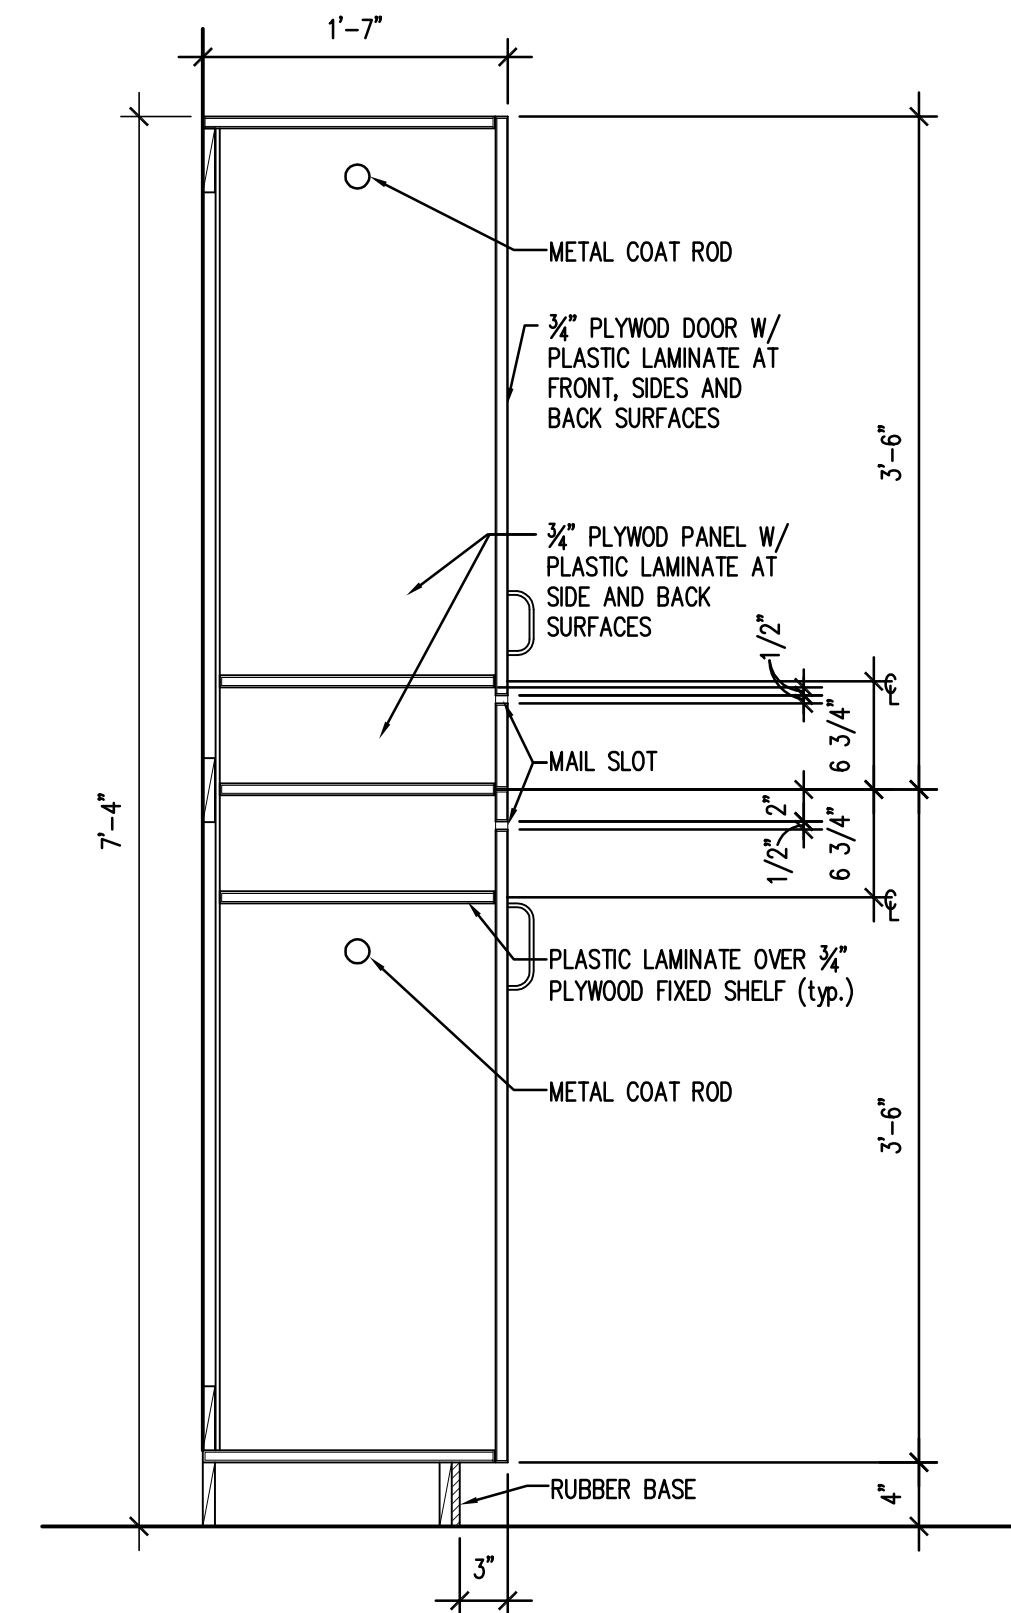


09 LOCKER SECTION

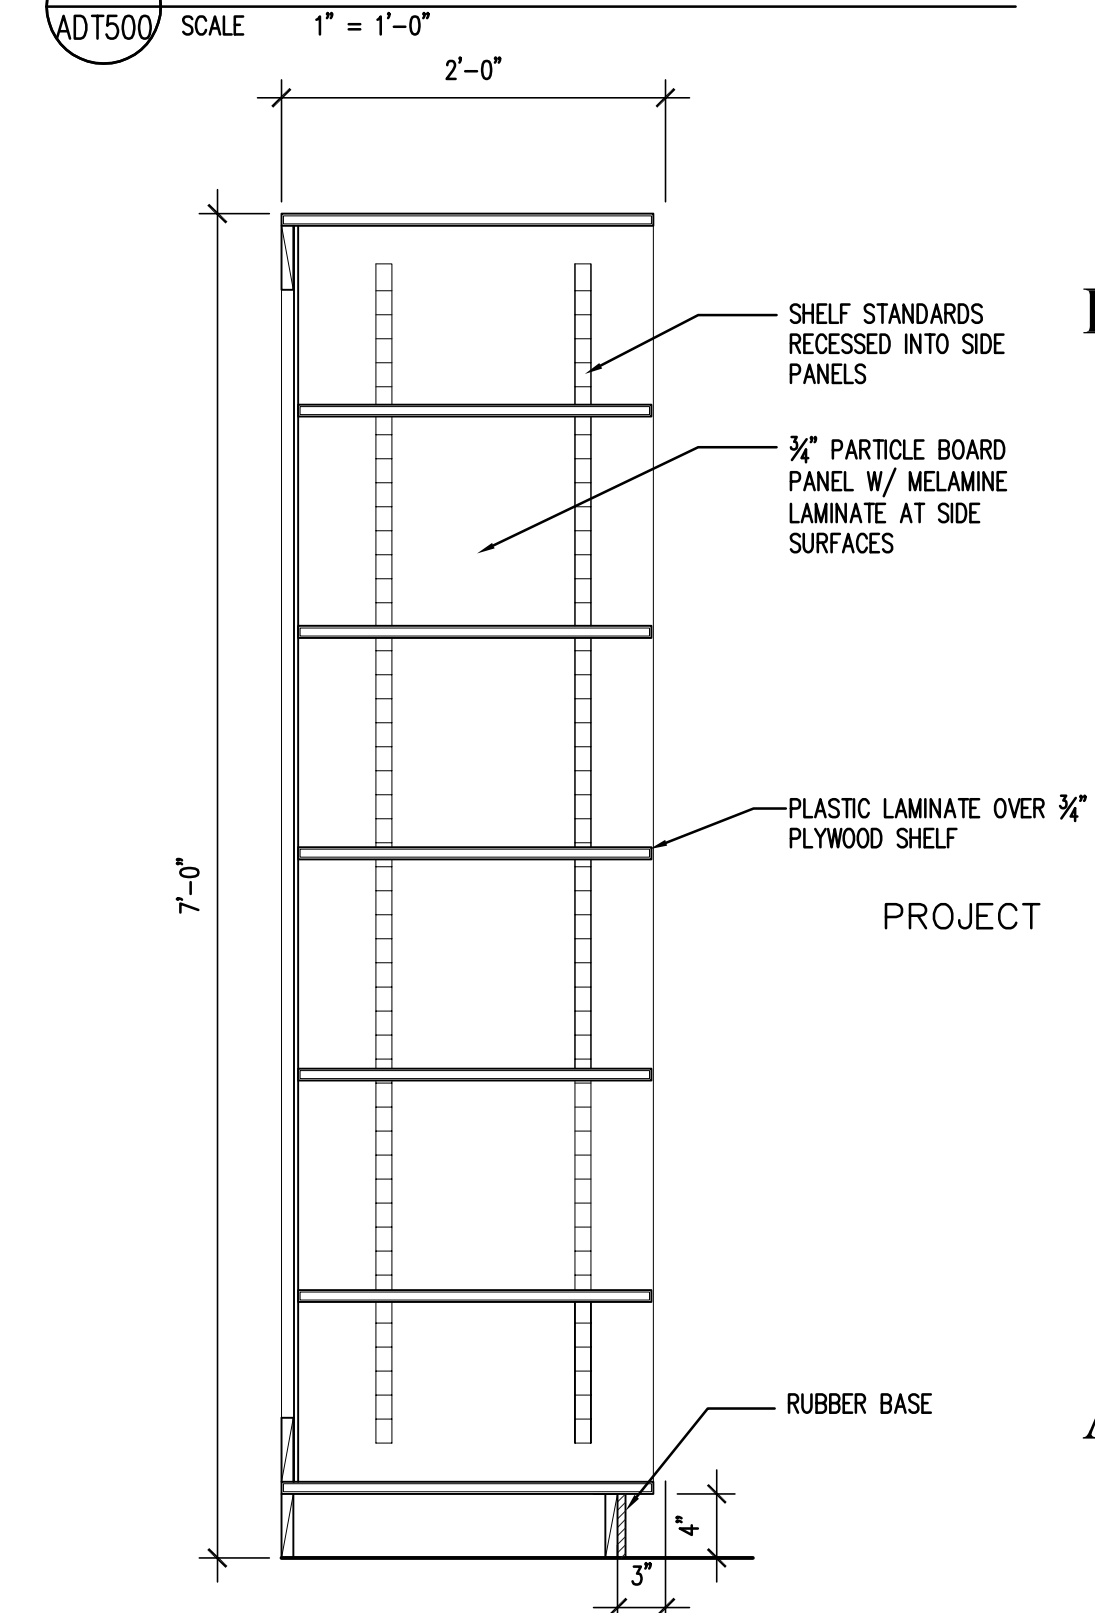

01 CASEWORK SECTION

821 East Kensington Ave.
Salt Lake City, Utah 84105
P: 801.484.1161
F: 801.485.4640
e-mail parchitects@comcast.net

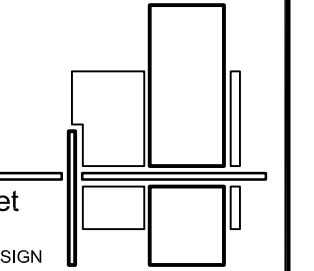

DFCM No. 06298550

MARK	DATE	REVISION
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WP


STAFF

CHECKED BY:
CLW


SLW
DATE: _____

01/15/08


HW JOB NO.: 06054

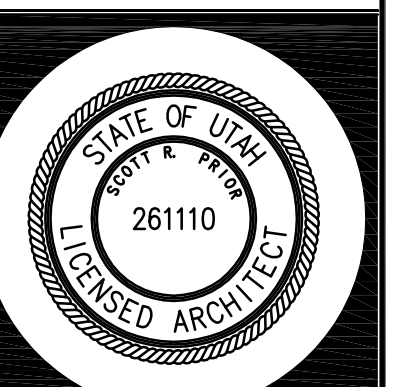06054
 SHEET TITLE


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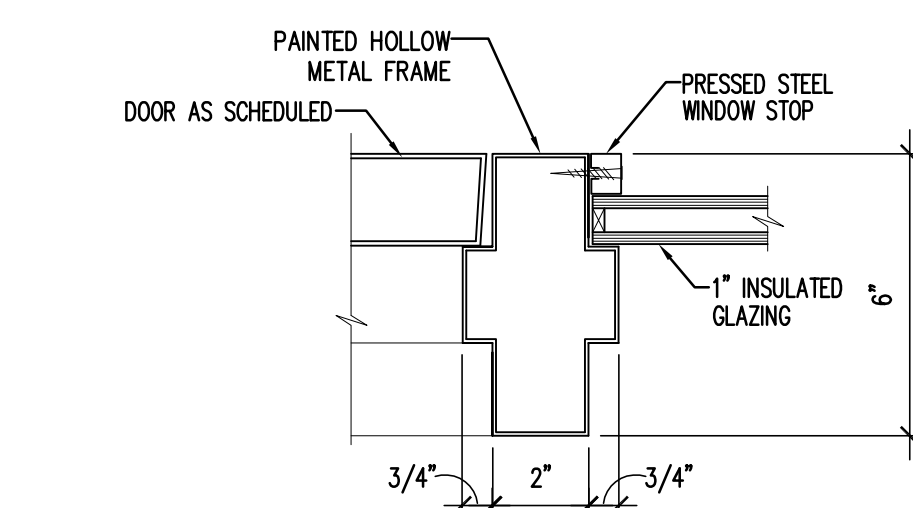
12
ADT500 SCALE 1/4" = 1'-0"

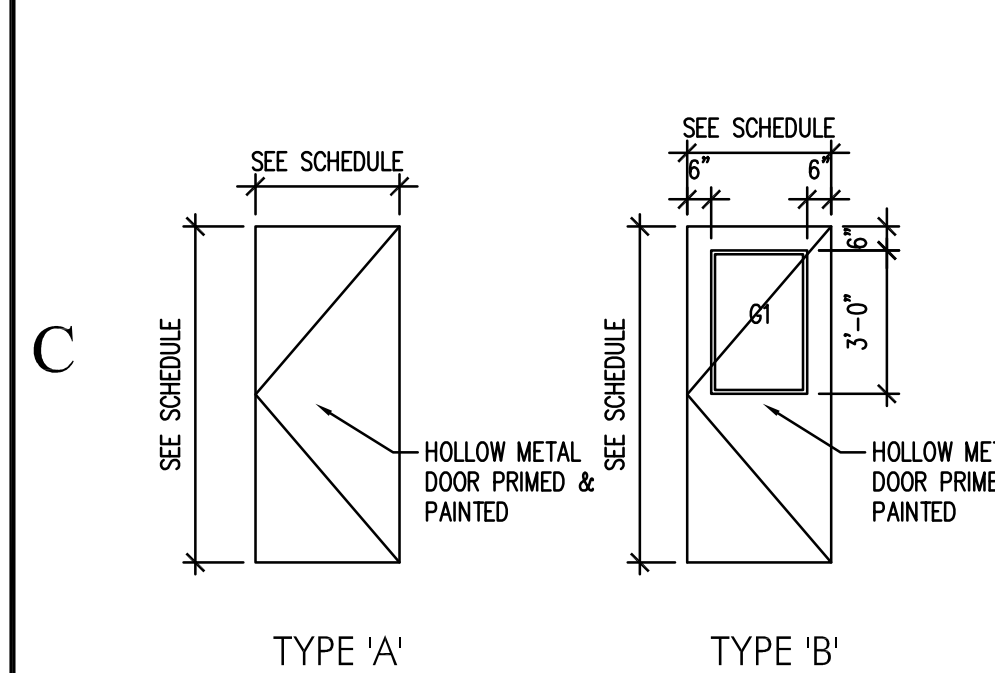


11 DOOR & WINDOW FRAME TYPES
SCALE 1/4" = 1'-0"

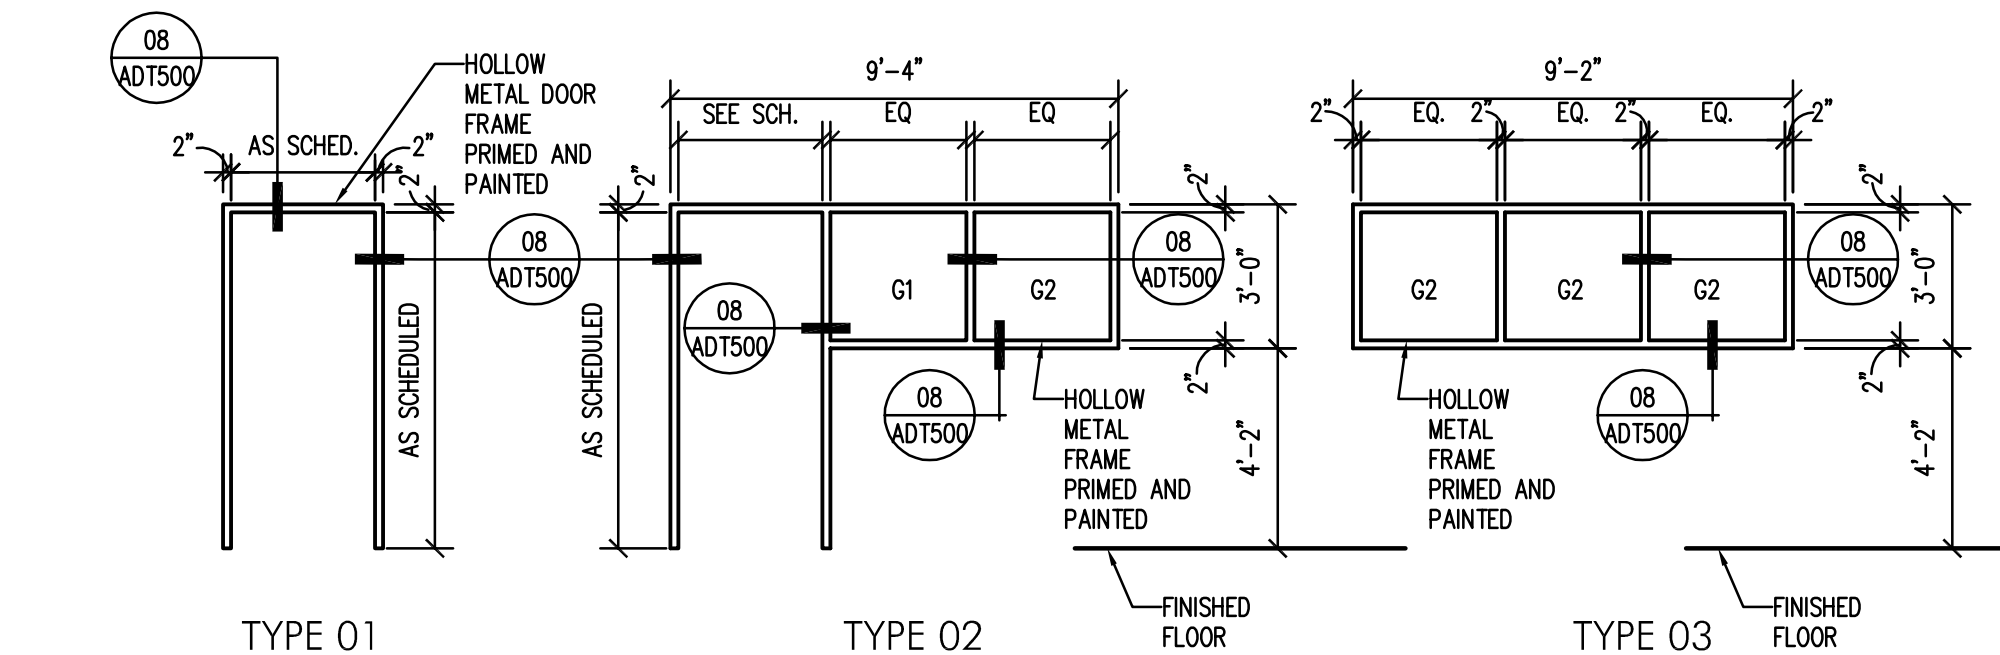


08 JAMB / HEAD DETAIL
ADT500 SCALE 3" = 1'-0"

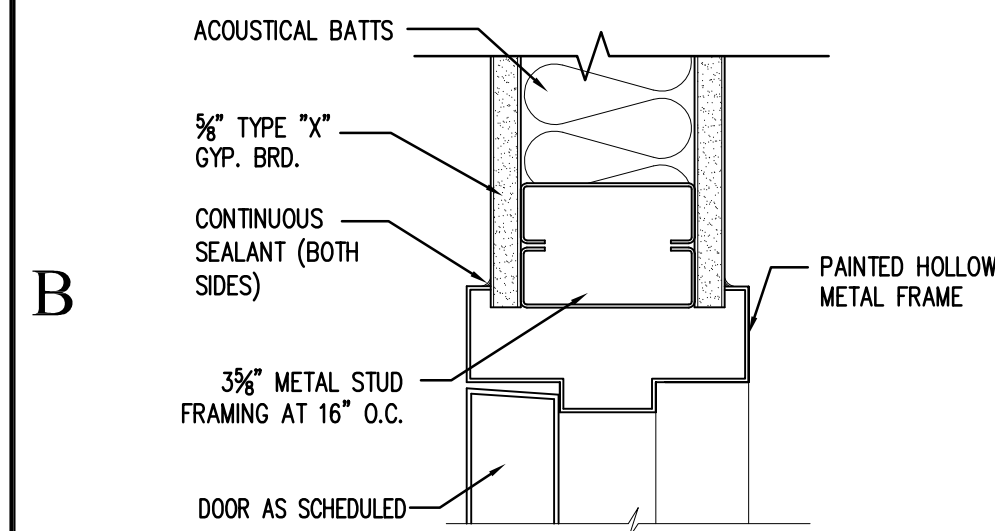

05.dwg 07 JAMB DETAIL
ADT500 SCALE 3" = 1'-0"

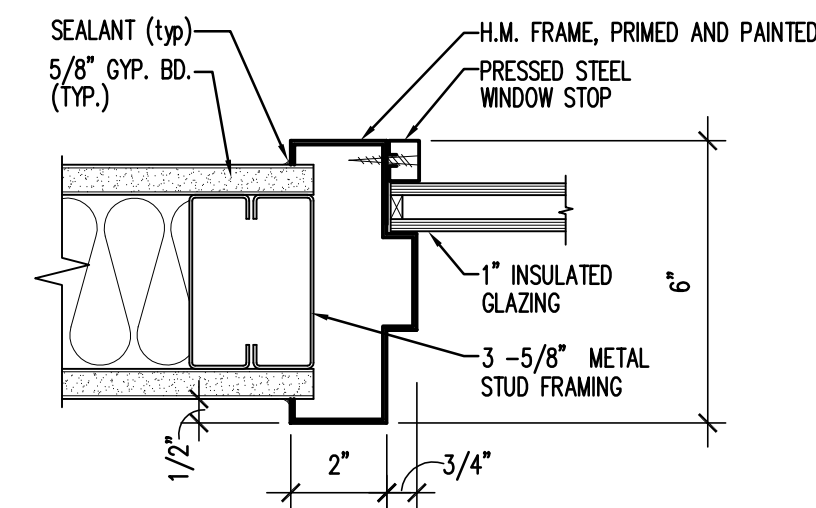


WINDOW DETAIL

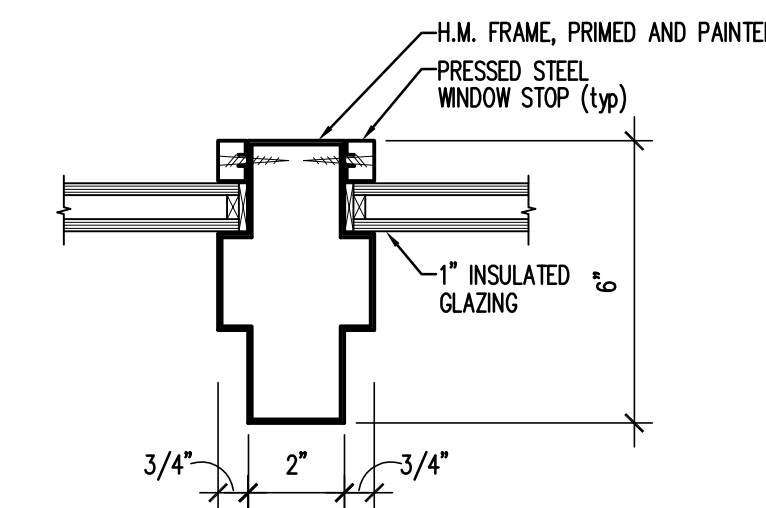


WINDOW DETAIL


SCALE 3" = 1'-0"

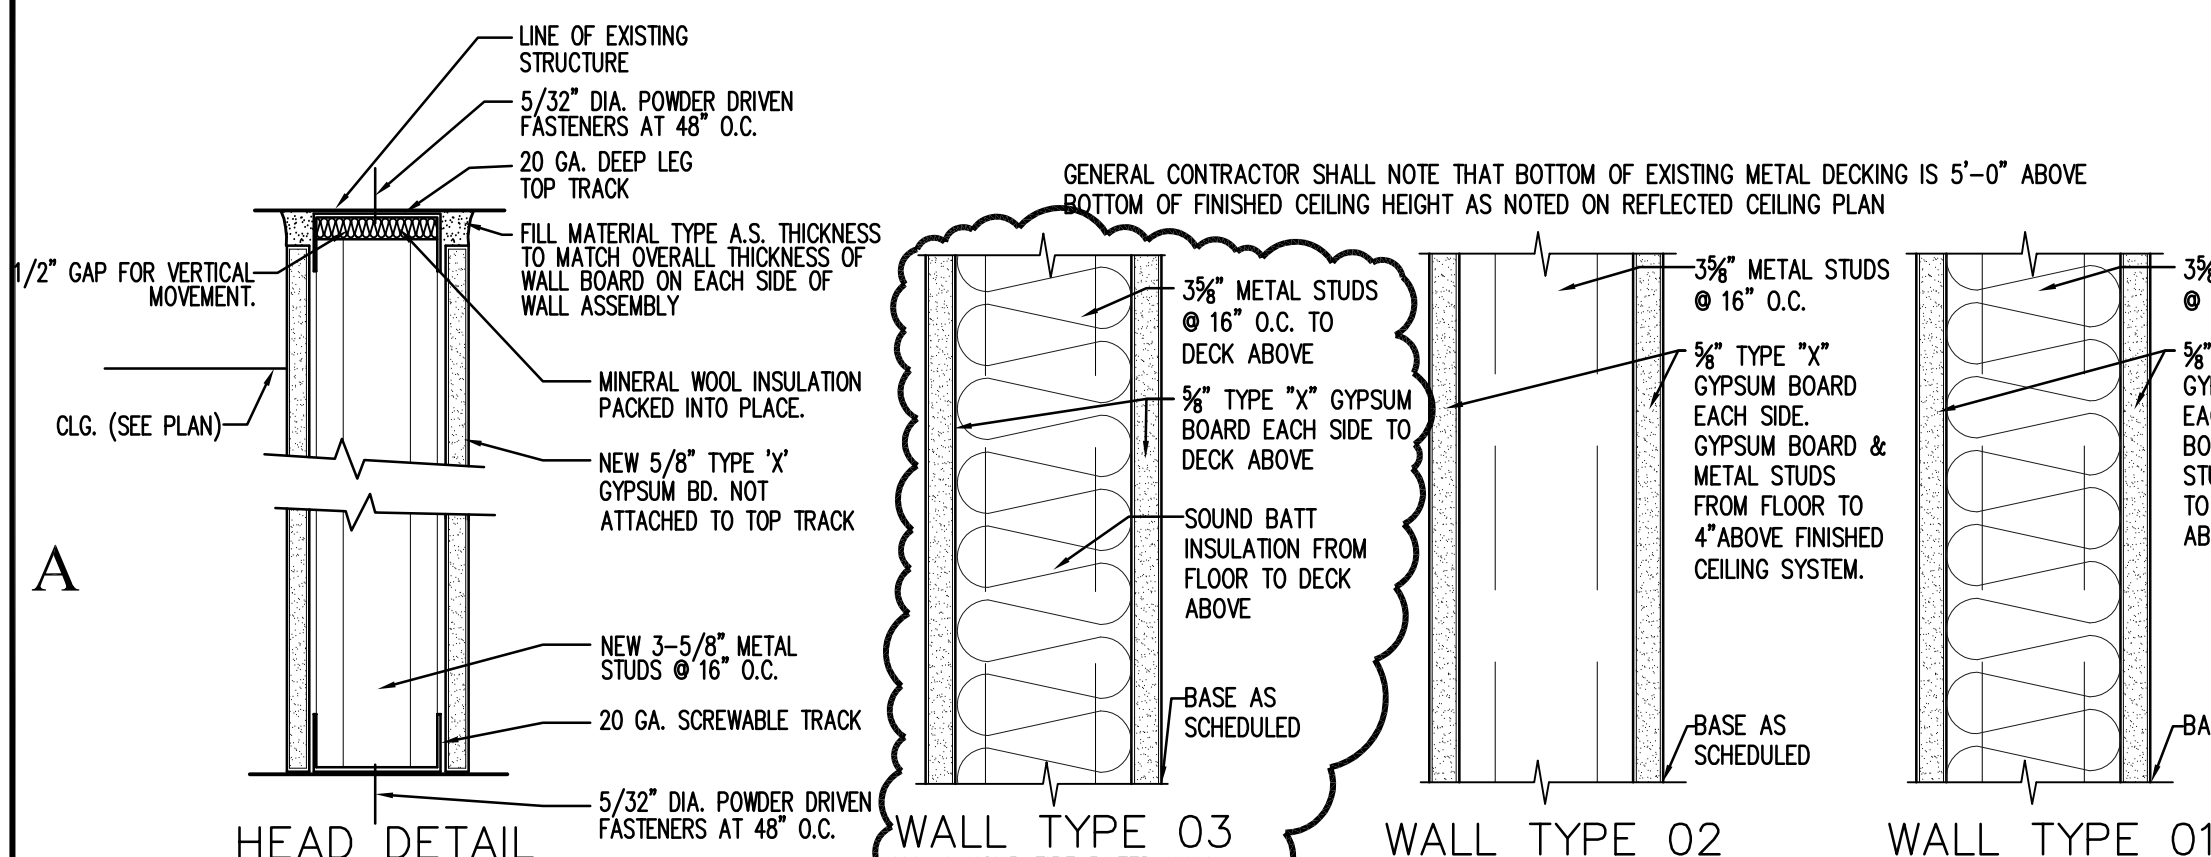


04 WALL TYPES
ADT500 SCALE 3" = 1'-0"

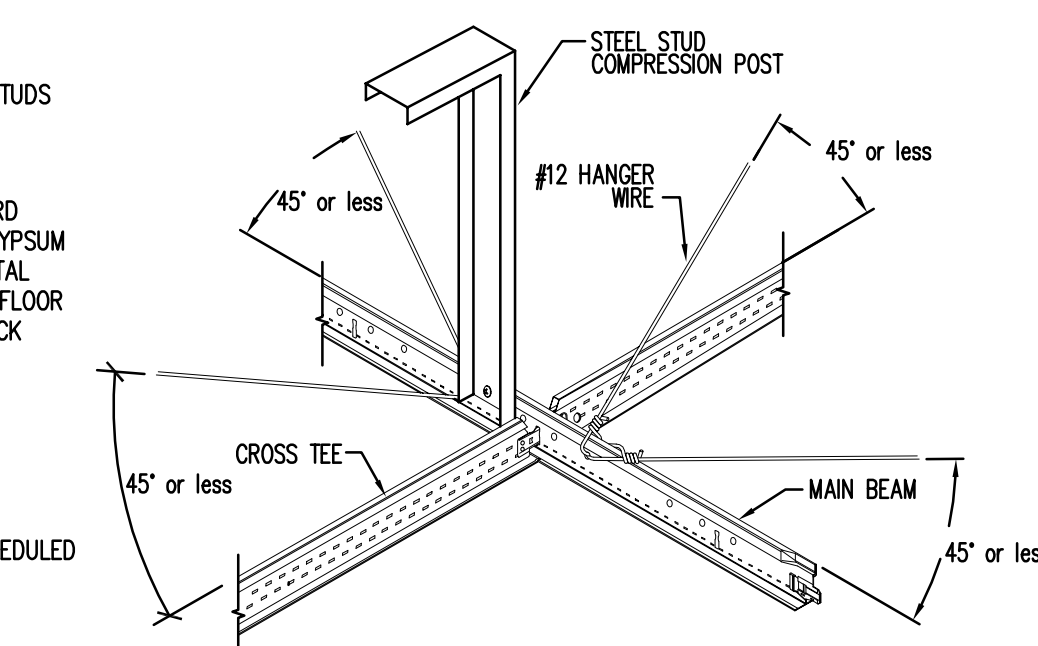

03 HORIZONTAL RESTRAINT
ADT500 SCALE 3" = 1'-0"

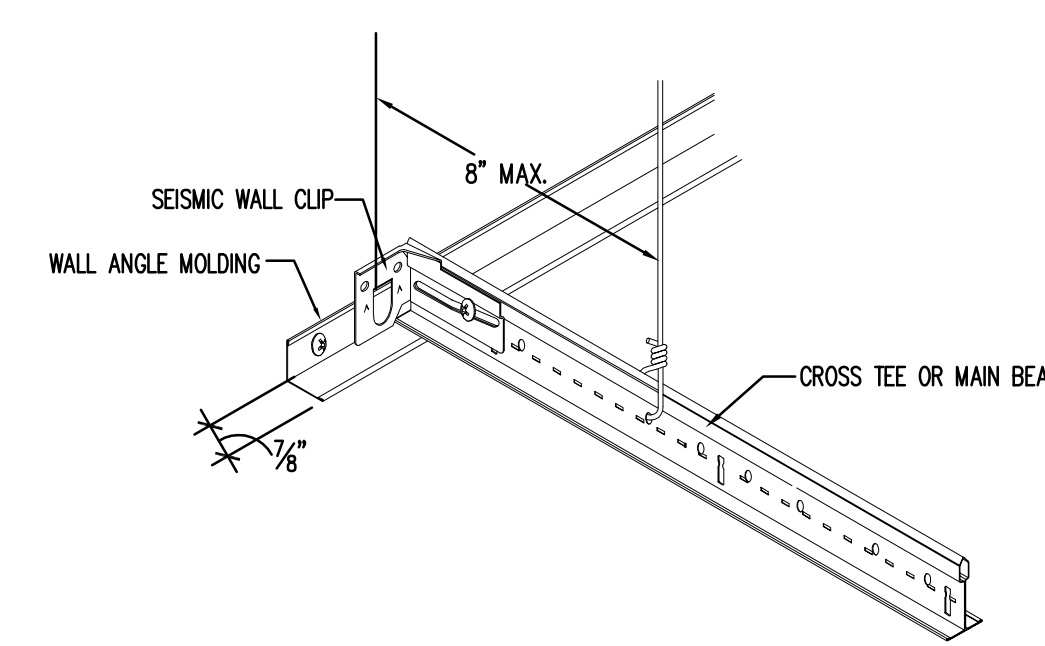

02.dwg 02 LAY-IN CEILING DETAIL
ADT500 SCALE 3" = 1'-0"

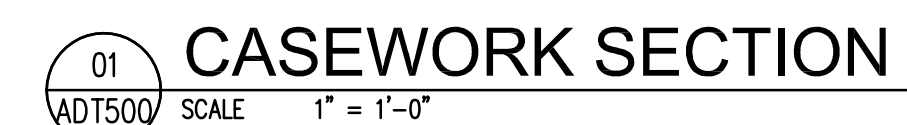


WHW
ENGINEERING INC.
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(801)466-4021, FAX 466-8536
EMAIL: excellence@whw-engineering.com

Richfield, Utah 84701

IV

RF	RELIEF AIR
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ALL MECHANICAL SHALL BE INSTALLED AND CONFORM TO THE 2003 EDITION OF THE IMC WITH UTAH ANNOTATIONS AND LOCAL AUTHORITY REQUIREMENTS.

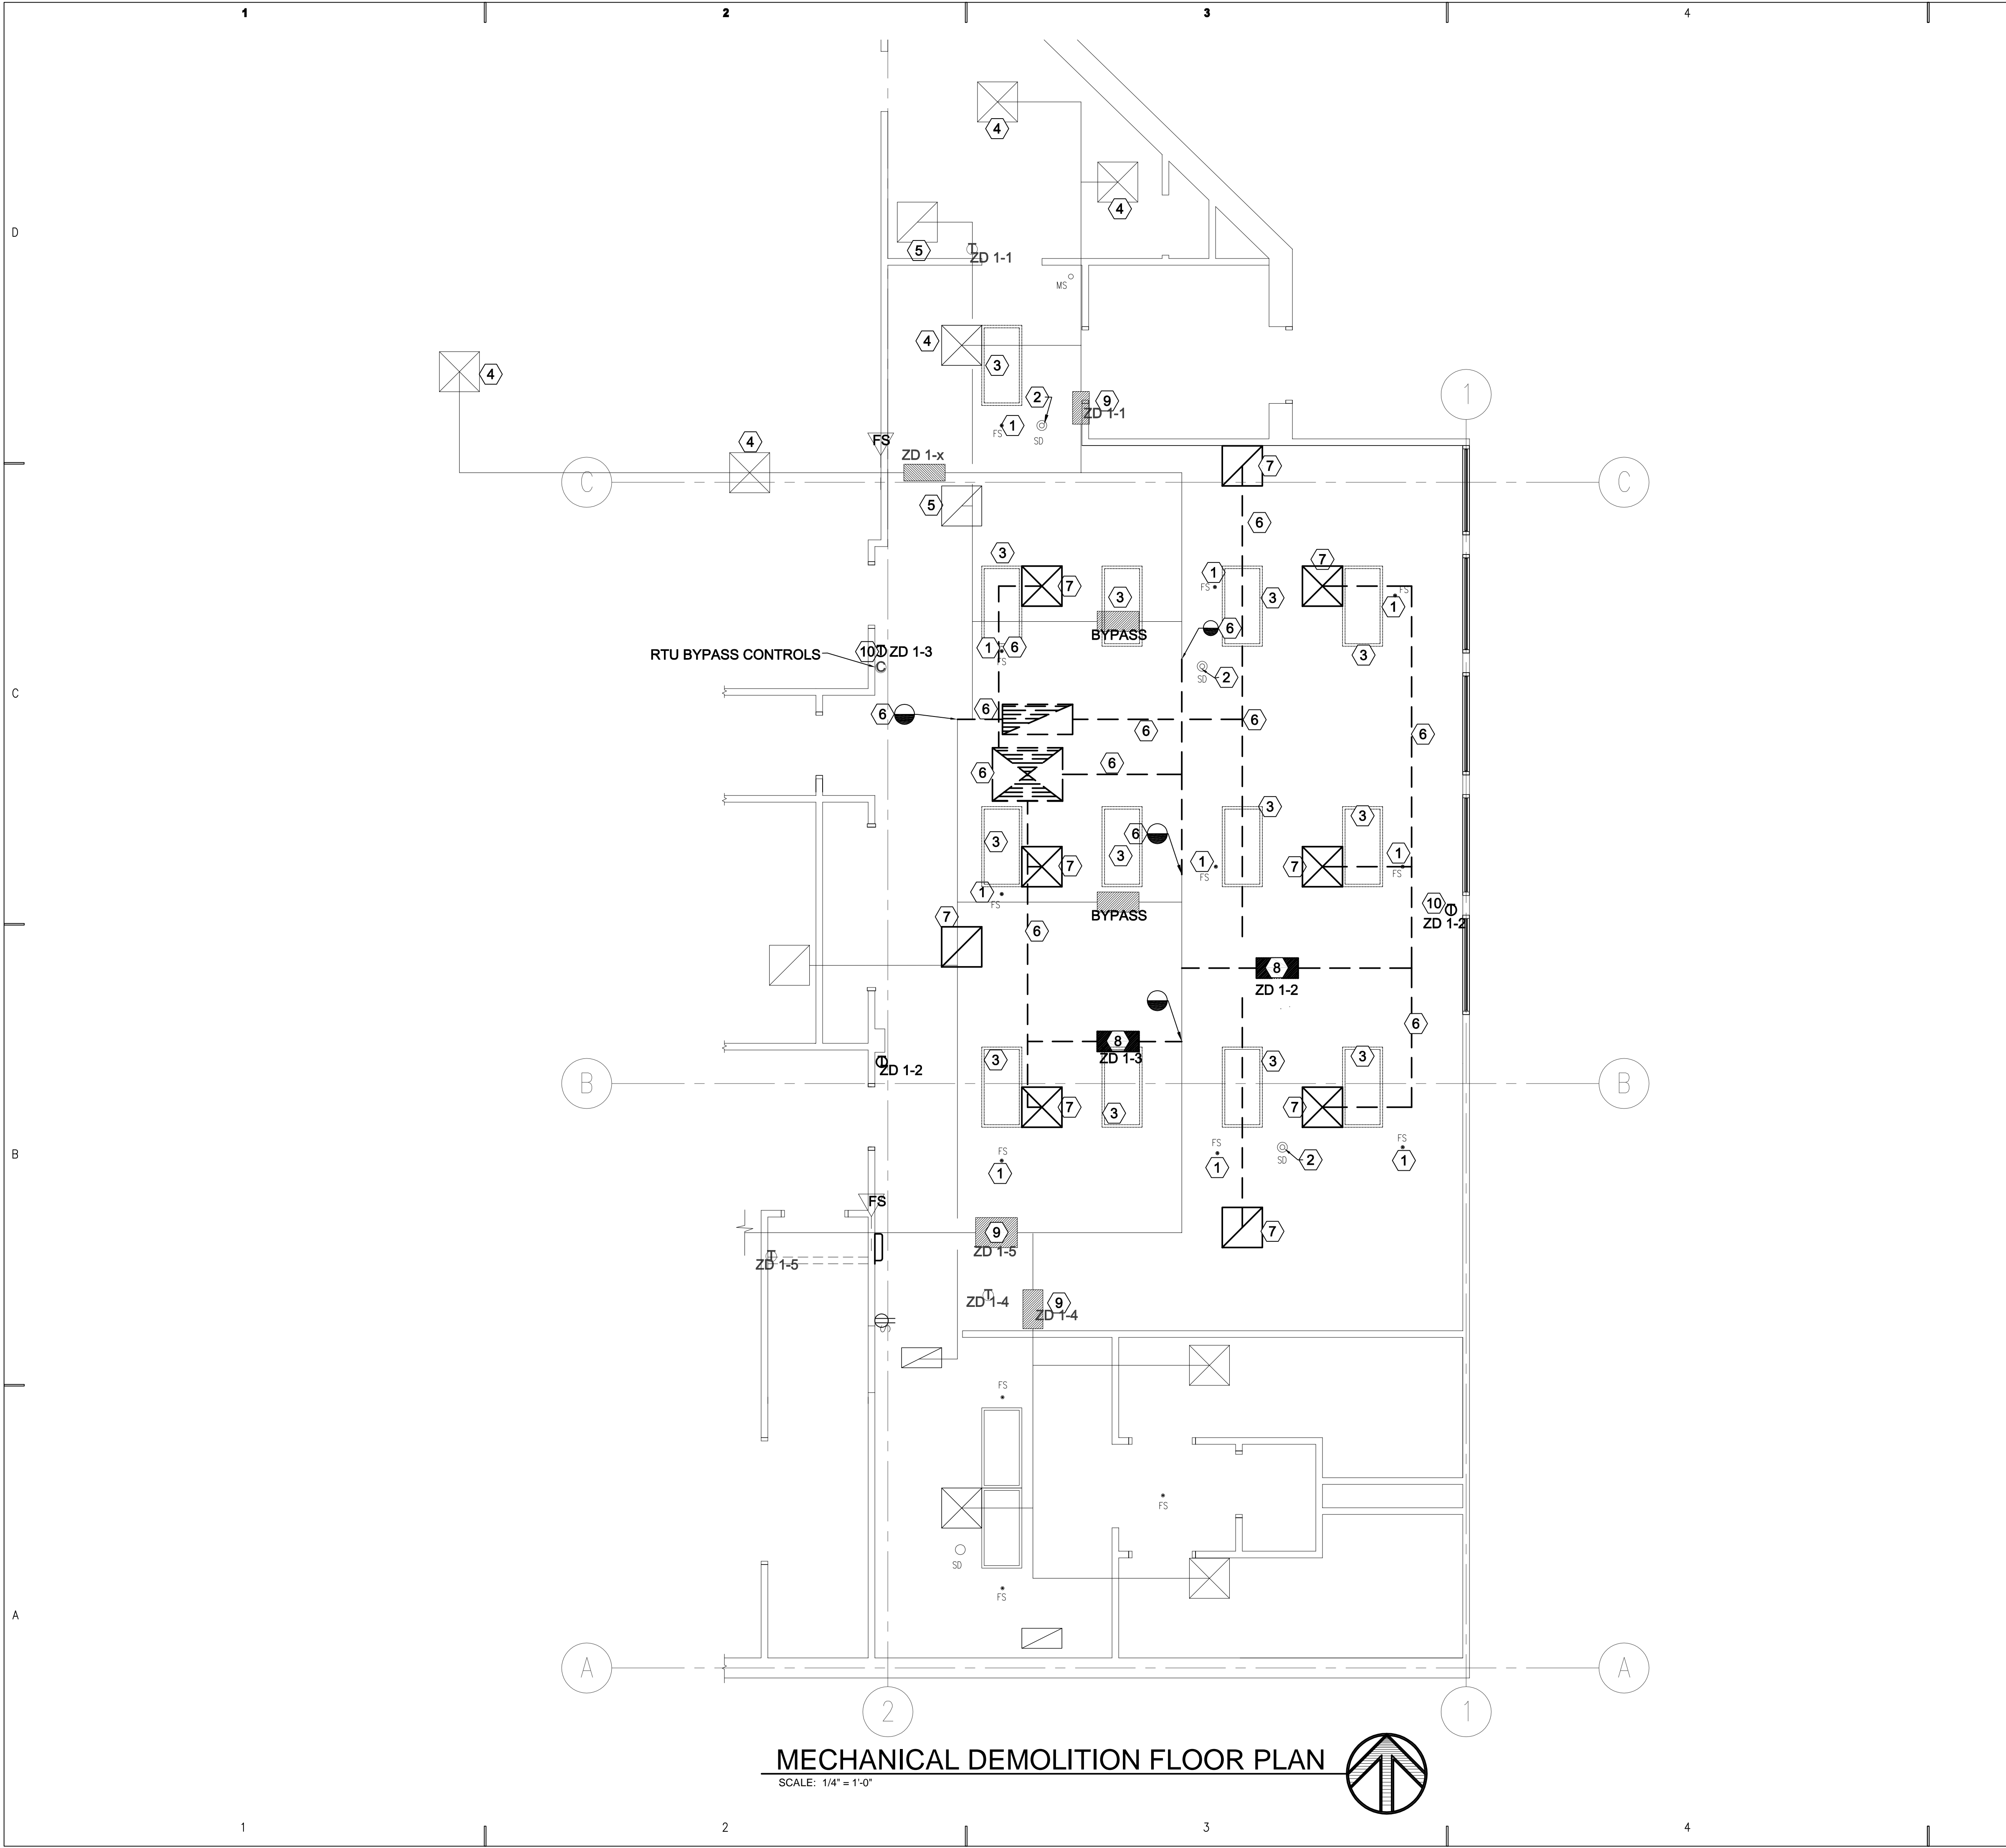


MECHANICAL DEMOLITION FLOOR PLAN

SCALE: 1/4" = 1'-0"


SHEET NOTES

- 1 EXISTING SPRINKLER HEAD.
- 2 EXISTING SMOKE DETECTOR.
- 3 EXISTING 2x4' FLOURESCENT LAY-IN LIGHT
- 4 EXISTING CEILING DIFFUSER.
- 5 EXISTING CEILING RETURN AIR GRILLE.
- 6 DEMO DUCTWORK AS SHOWN.
- 7 DEMO DIFFUSER / GRILLE AS SHOWN
- 8 DEMO ZONE DAMPER
- 9 EXISTING ZONE DAMPER
- 10 DEMO ZONE THERMOSTAT

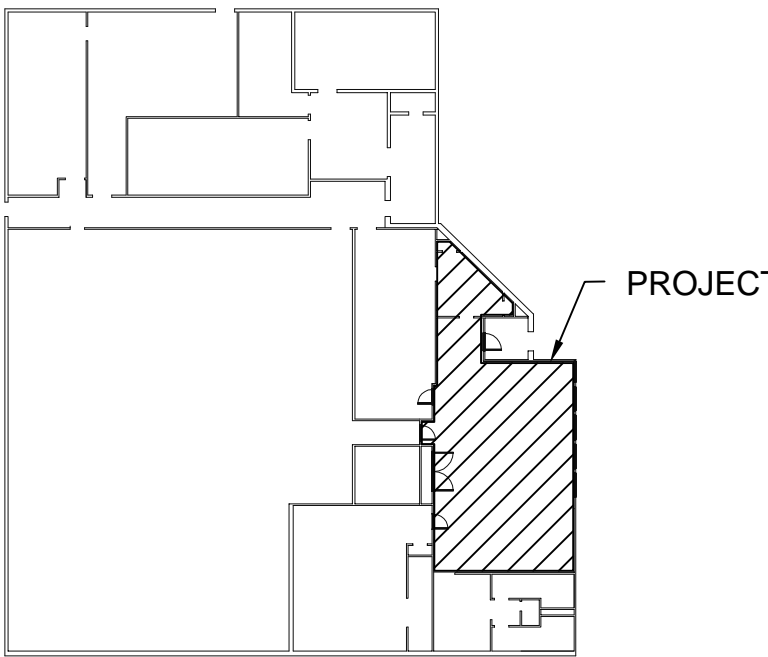


KEY PLAN

SCALE: NONE

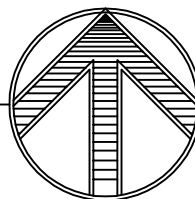

State of Utah
Department of Administrative Services

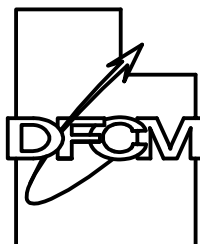

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Salt Lake City, Utah 84114
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PROJECT NAME & ADDRESS

**DEPARTMENT OF
SAFETY
RICHFIELD ITS UHP
DISPATCH
MODIFICATION**

DFCM No. 06298550

Richfield, Utah 84701

MARK	DATE	REVISION

PROJECT MANAGER:

WP

DRAWN BY:

STAFF

CHECKED BY:

SLW


DATE:

01/22/08

WHW JOB NO.:

06054


SHEET TITLE

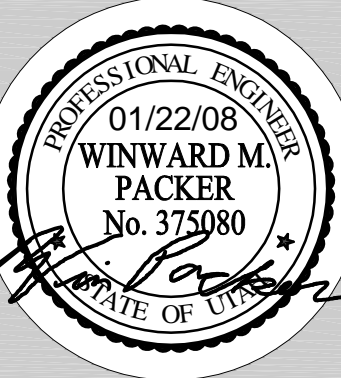

**MECHANICAL DEMOLITION
FLOOR PLAN**

SHEET NO.

MD101

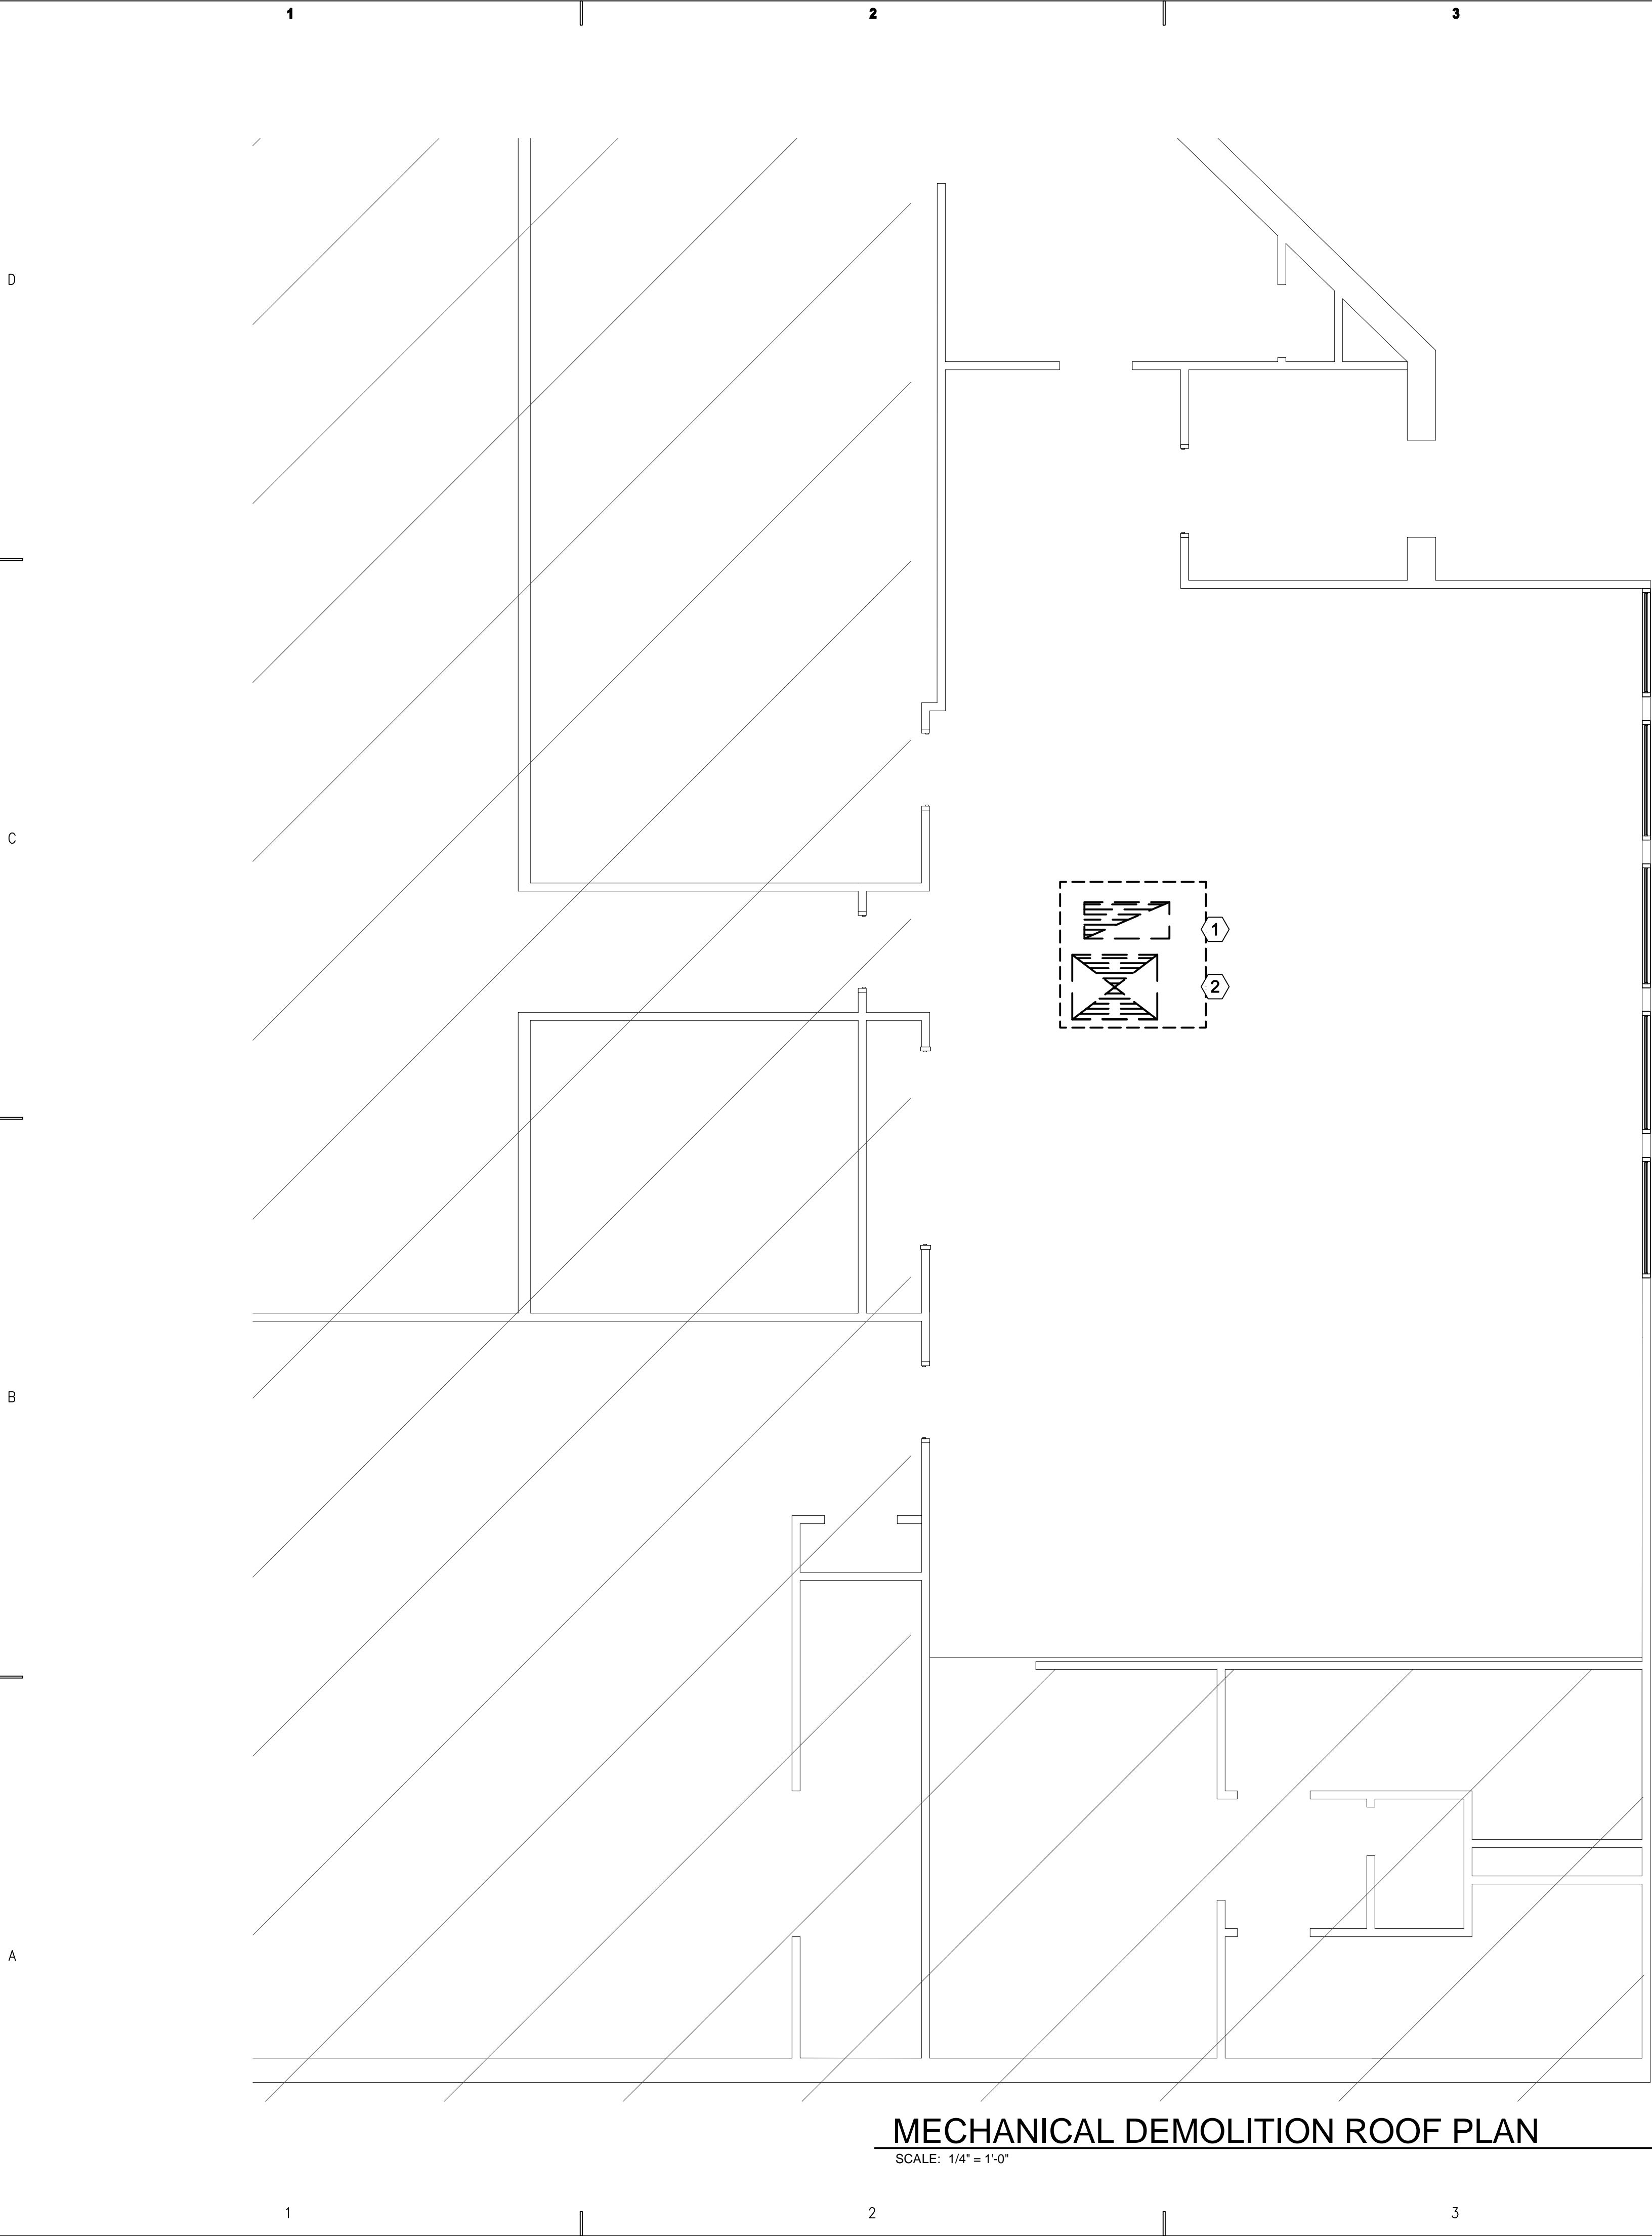


MECHANICAL DEMOLITION ROOF PLAN

SCALE: 1/4" = 1'-0"


SHEET NOTES

- ① DEMO ROOF TOP UNIT AND ASSOCIATED DUCT WORK AS SHOWN.
- ② EXISTING CURB TO REMAIN.

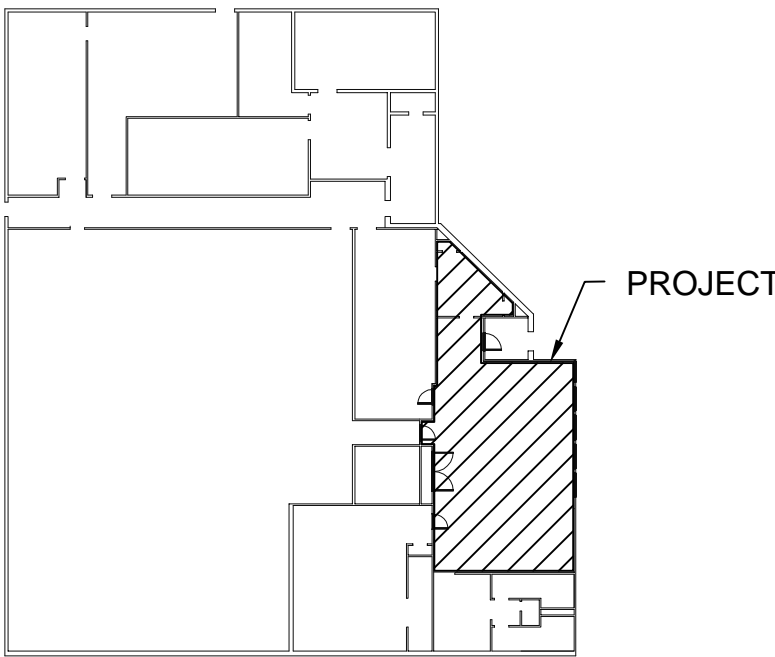


KEY PLAN

SCALE: NONE

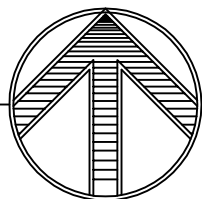

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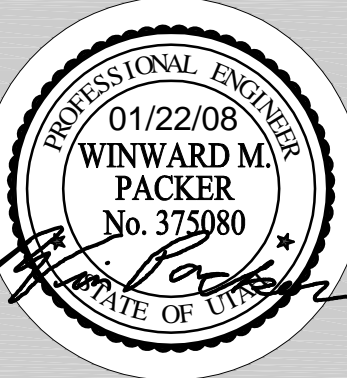
DATE:

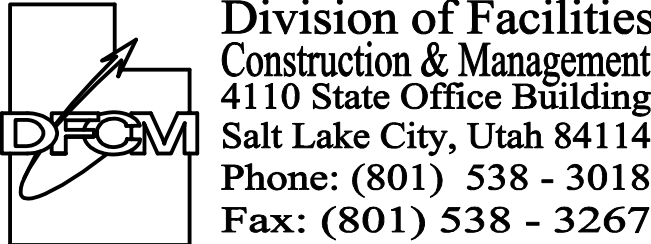01/22/08

WHW JOB NO.:

06054


SHEET TITLE



**MECHANICAL DEMOLITION
ROOF PLAN**

SHEET NO.

MD102

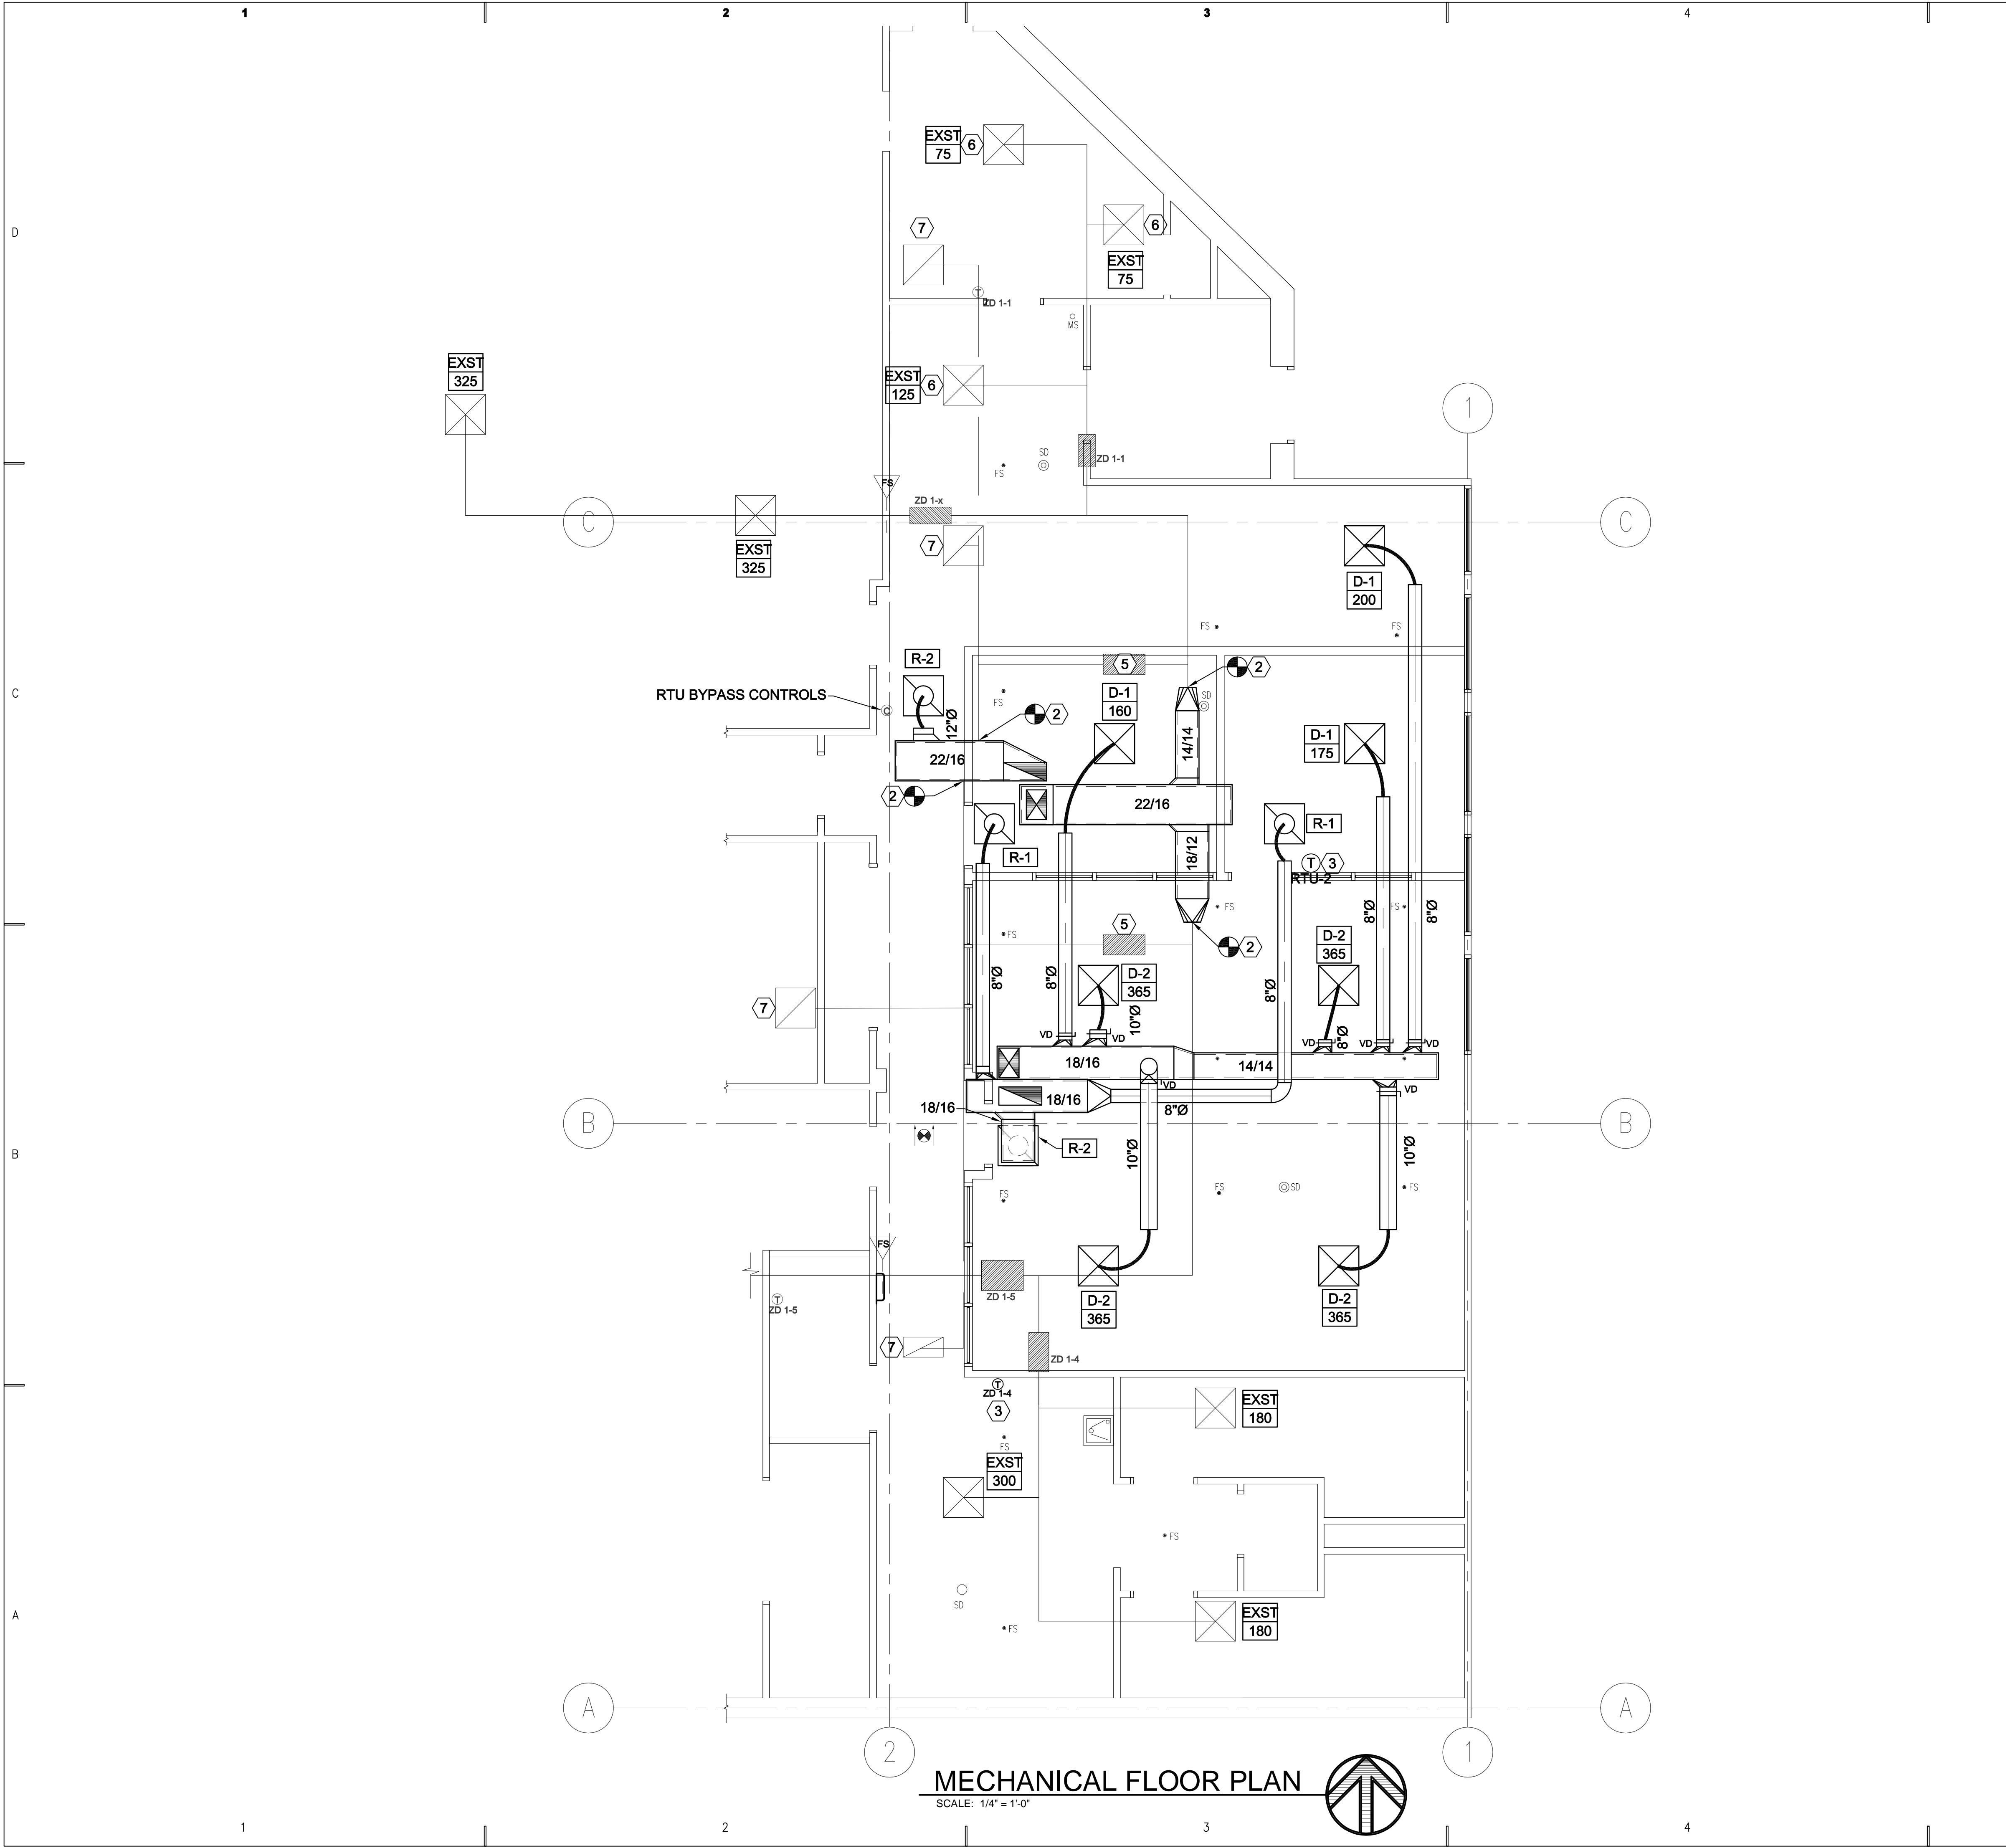

SHEET NOTES

- 1 TIE NEW RTU INTO EXISTING VVT BOX.
- 2 FIELD VERIFY EXACT POINT OF RE-CONNECTION.
- 3 CONFIRM EXACT THERMOSTAT PLACEMENT WITH OWNER.
- 4 EXISTING BYPASS DAMPER TO REMAIN. TIE INTO NEW ROOF TOP UNIT.
- 5 EXISTING BYPASS TO REMAIN.
- 6 EXISTING GRILLE TO REMAIN. PROVIDE VOLUME DAMPER IF EXISTING IS IN OPERABLE OR NOT IN PLACE.
- 7 EXISTING GRILLE TO REMAIN.

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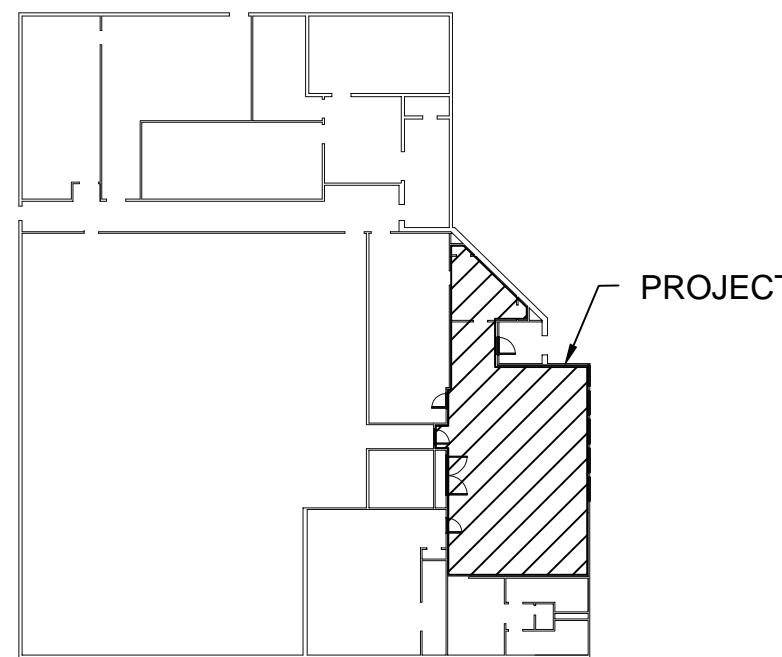
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SHEET TITLE

MECHANICAL FLOOR
PLAN


SHEET NO.

ME101



KEY PLAN

SCALE: NONE

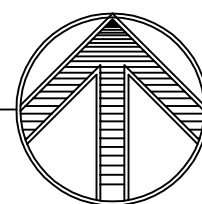


MECHANICAL FLOOR PLAN

SCALE: 1/4" = 1'-0"




MECHANICAL ROOF PLAN

SCALE: 1/4" = 1'-0"

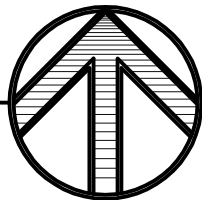


SHEET NOTES

- 1 PROVIDE ADAPTER CURB TO TIE NEW ROOF TOP UNIT INTO EXISTING ROOF CURB.
- 2 PROVIDE VVT CONTROLS TO COMMUNICATE WITH EXISTING SYSTEM IN PLACE.

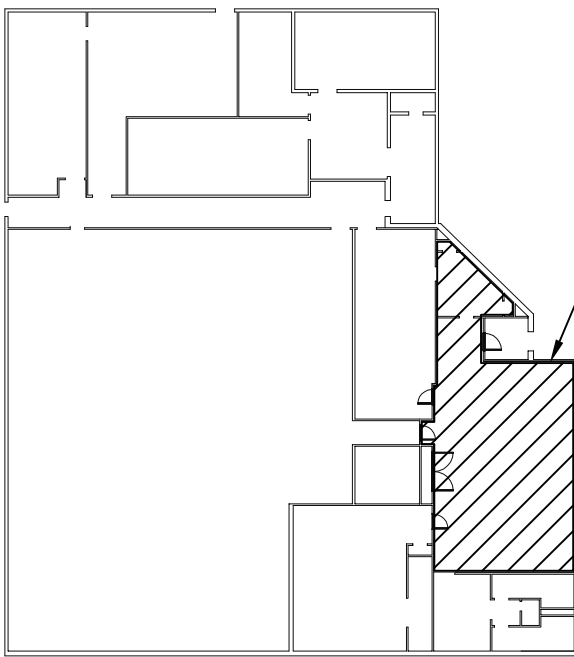


KEY PLAN

SCALE: NONE

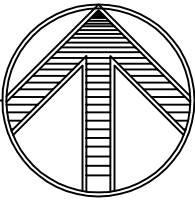

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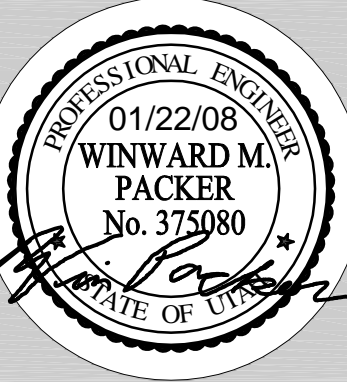
**DEPARTMENT OF
SAFETY
RICHFIELD ITS UHP
DISPATCH
MODIFICATION**

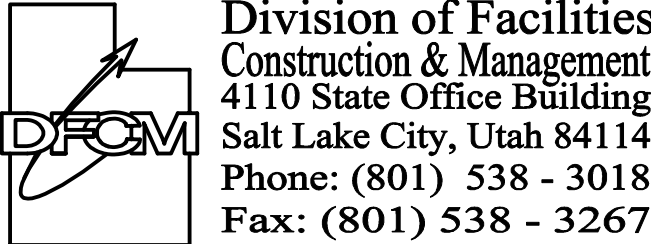DFCM No. 06298550

Richfield, Utah 84701

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DRAWN BY:
STAFF
CHECKED BY:
SLW
DATE:
01/22/08
WHW JOB NO.:
06054
SHEET TITLE




MECHANICAL ROOF PLAN


SHEET NO.

ME102


D
C
B
A

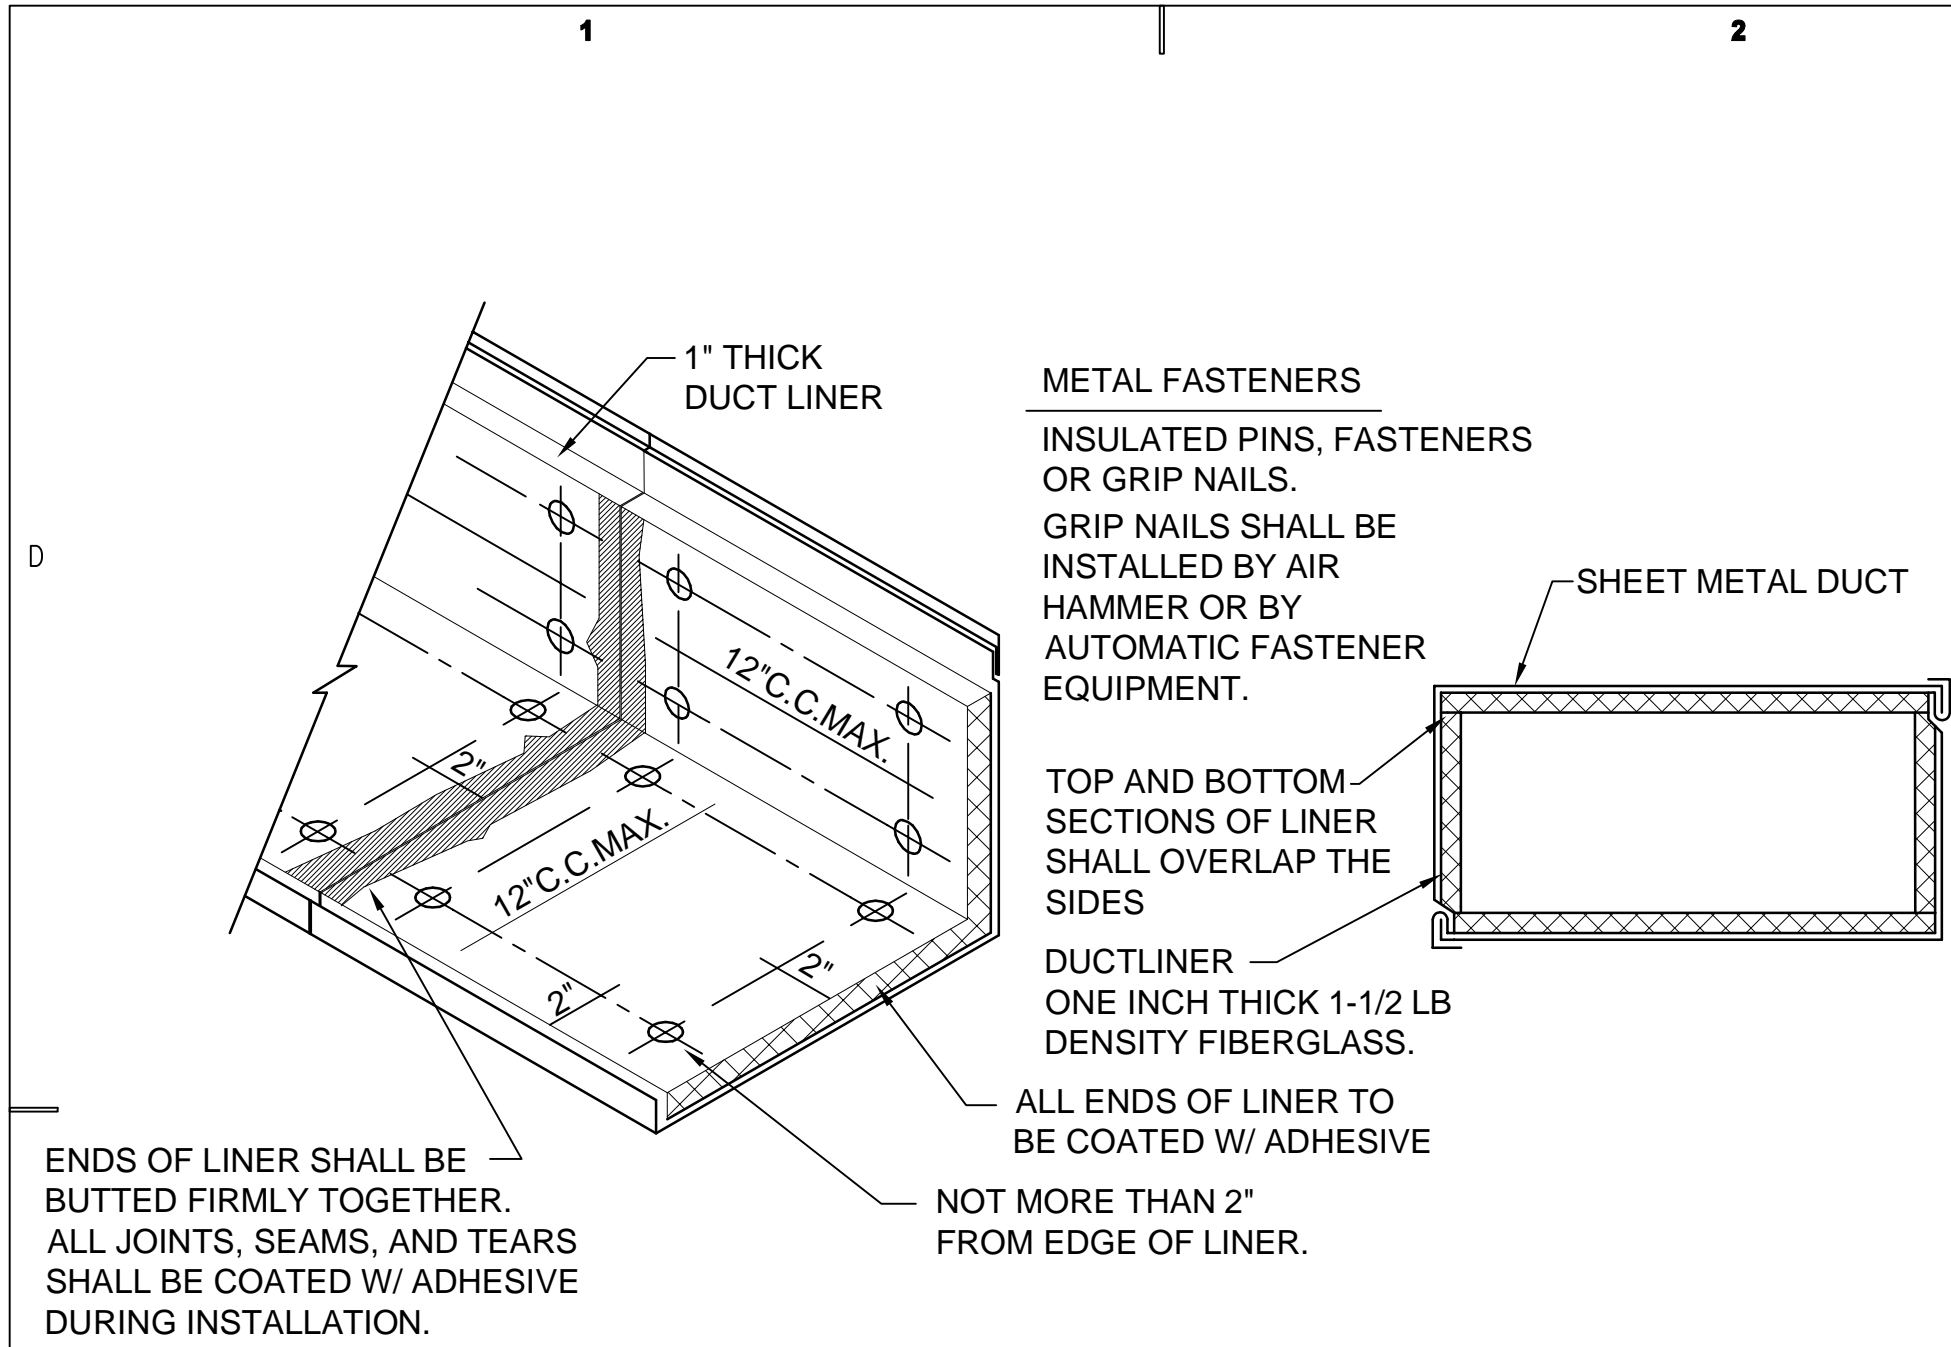


C1 DUCT LINER DETAIL
SCALE: NONE

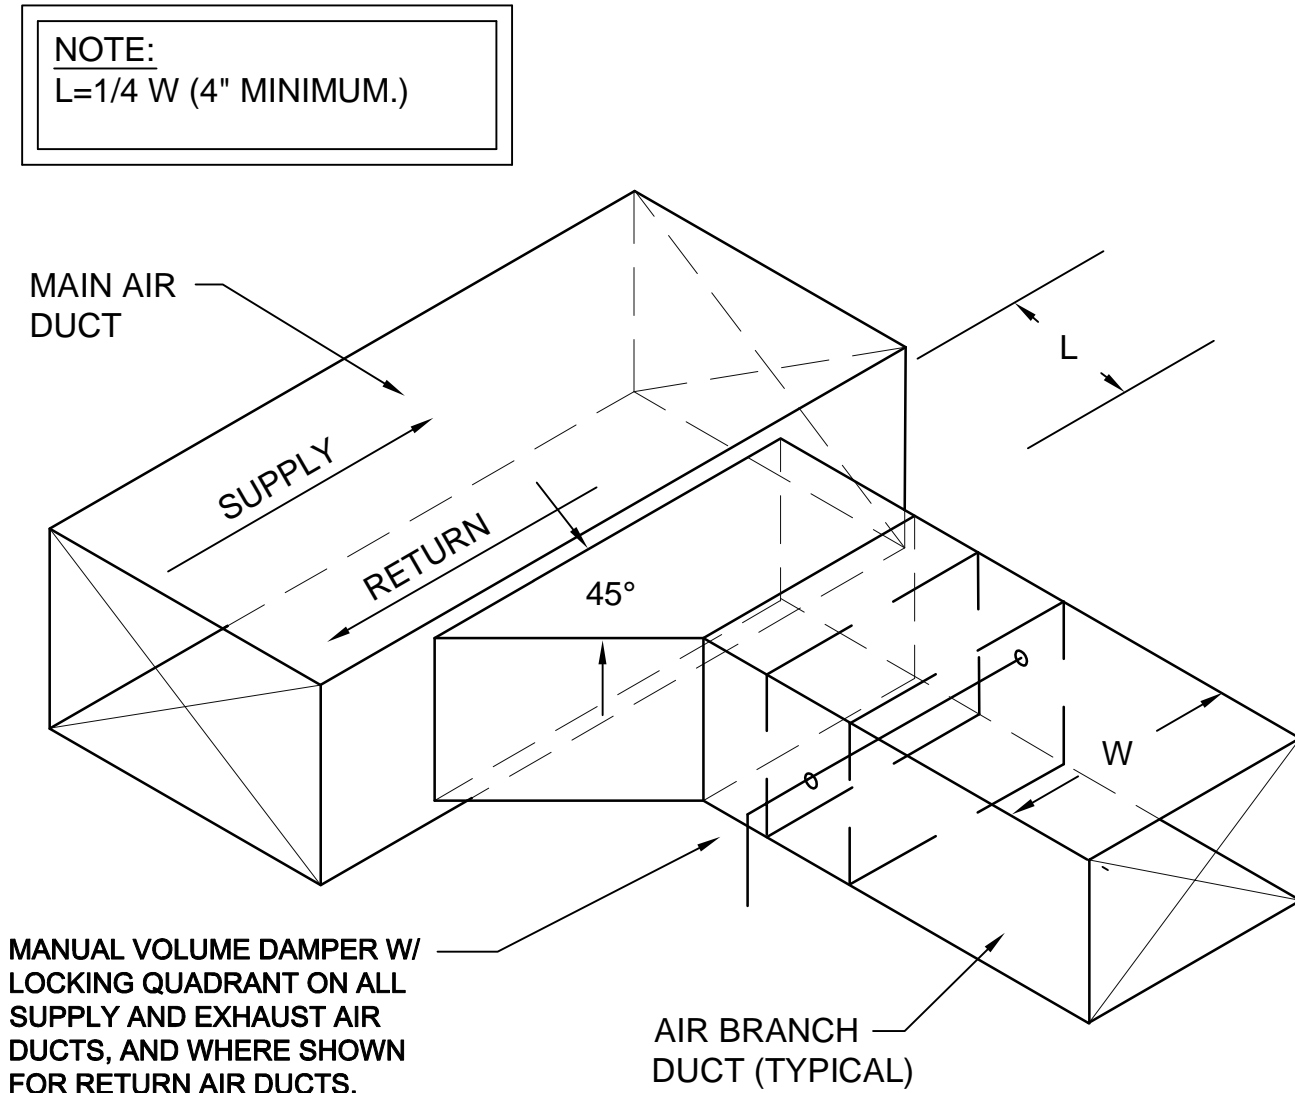


C3 BRANCH DUCT TAKE-OFF & DAMPER DETAIL
SCALE: NONE

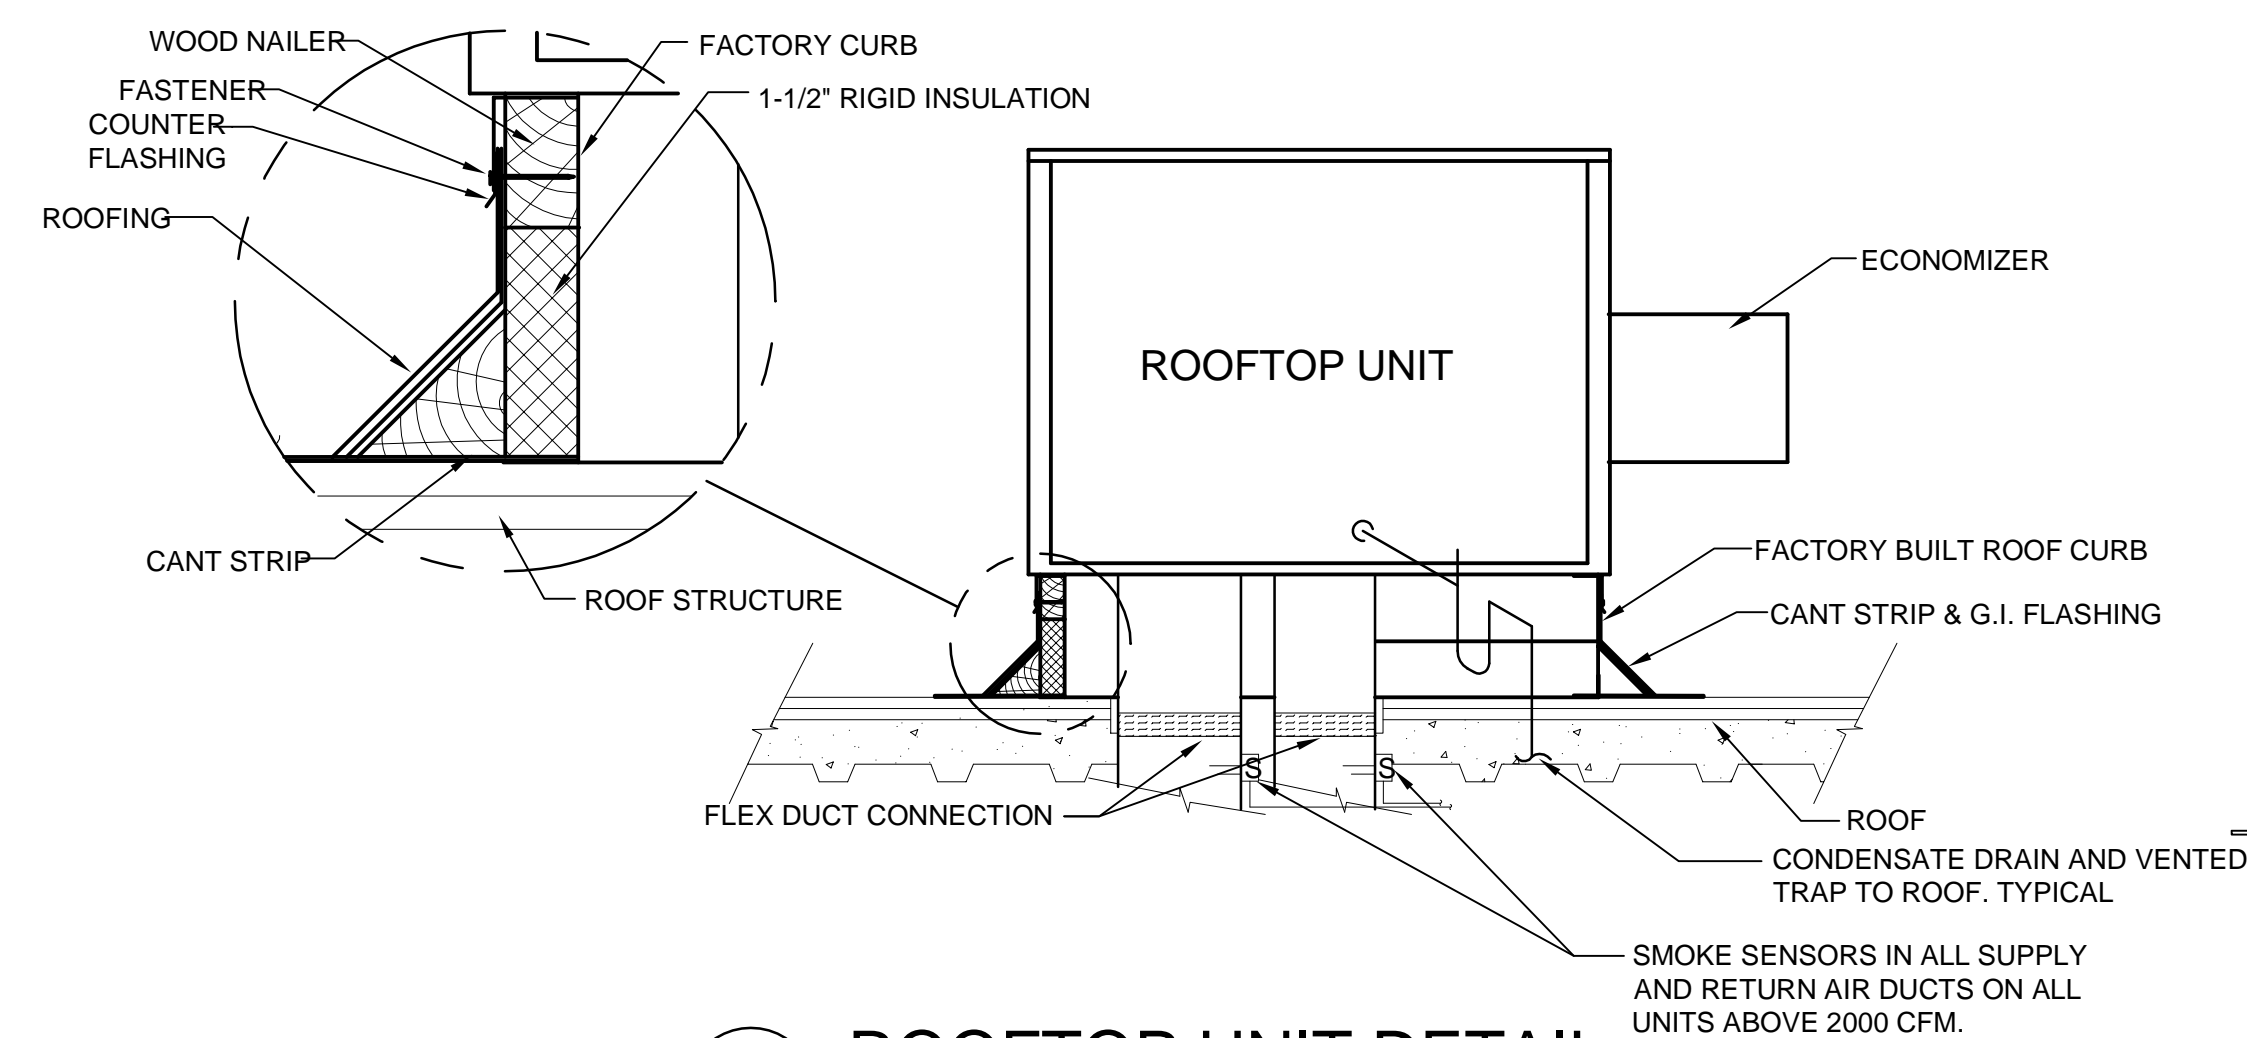


C4 ROOFTOP UNIT DETAIL
SCALE: NONE

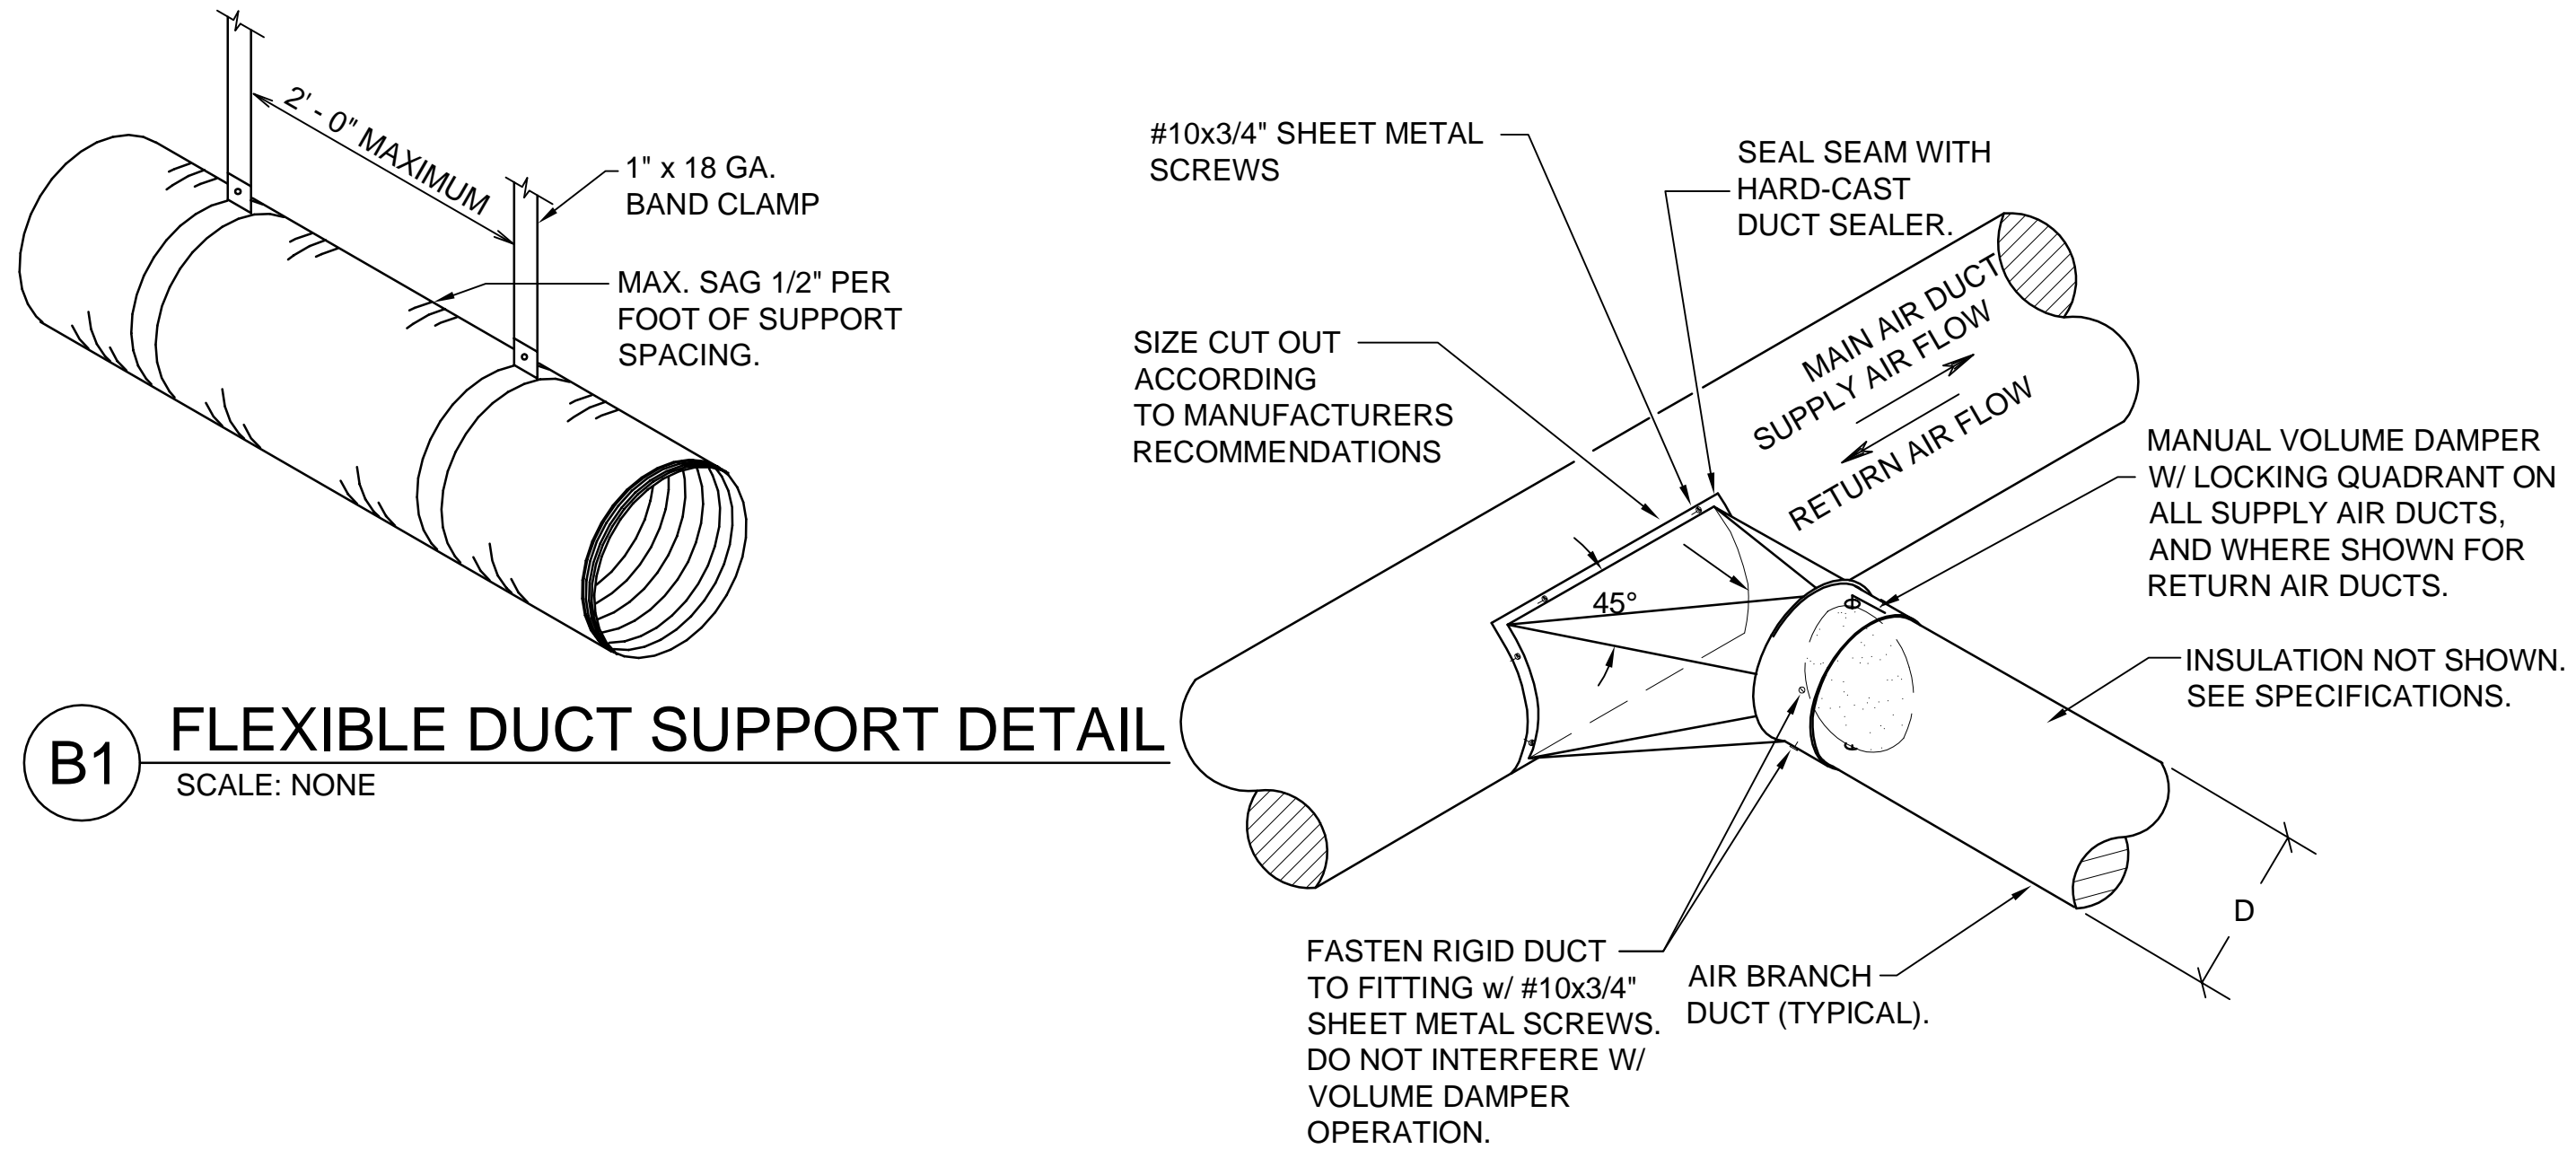


B1 FLEXIBLE DUCT SUPPORT DETAIL
SCALE: NONE

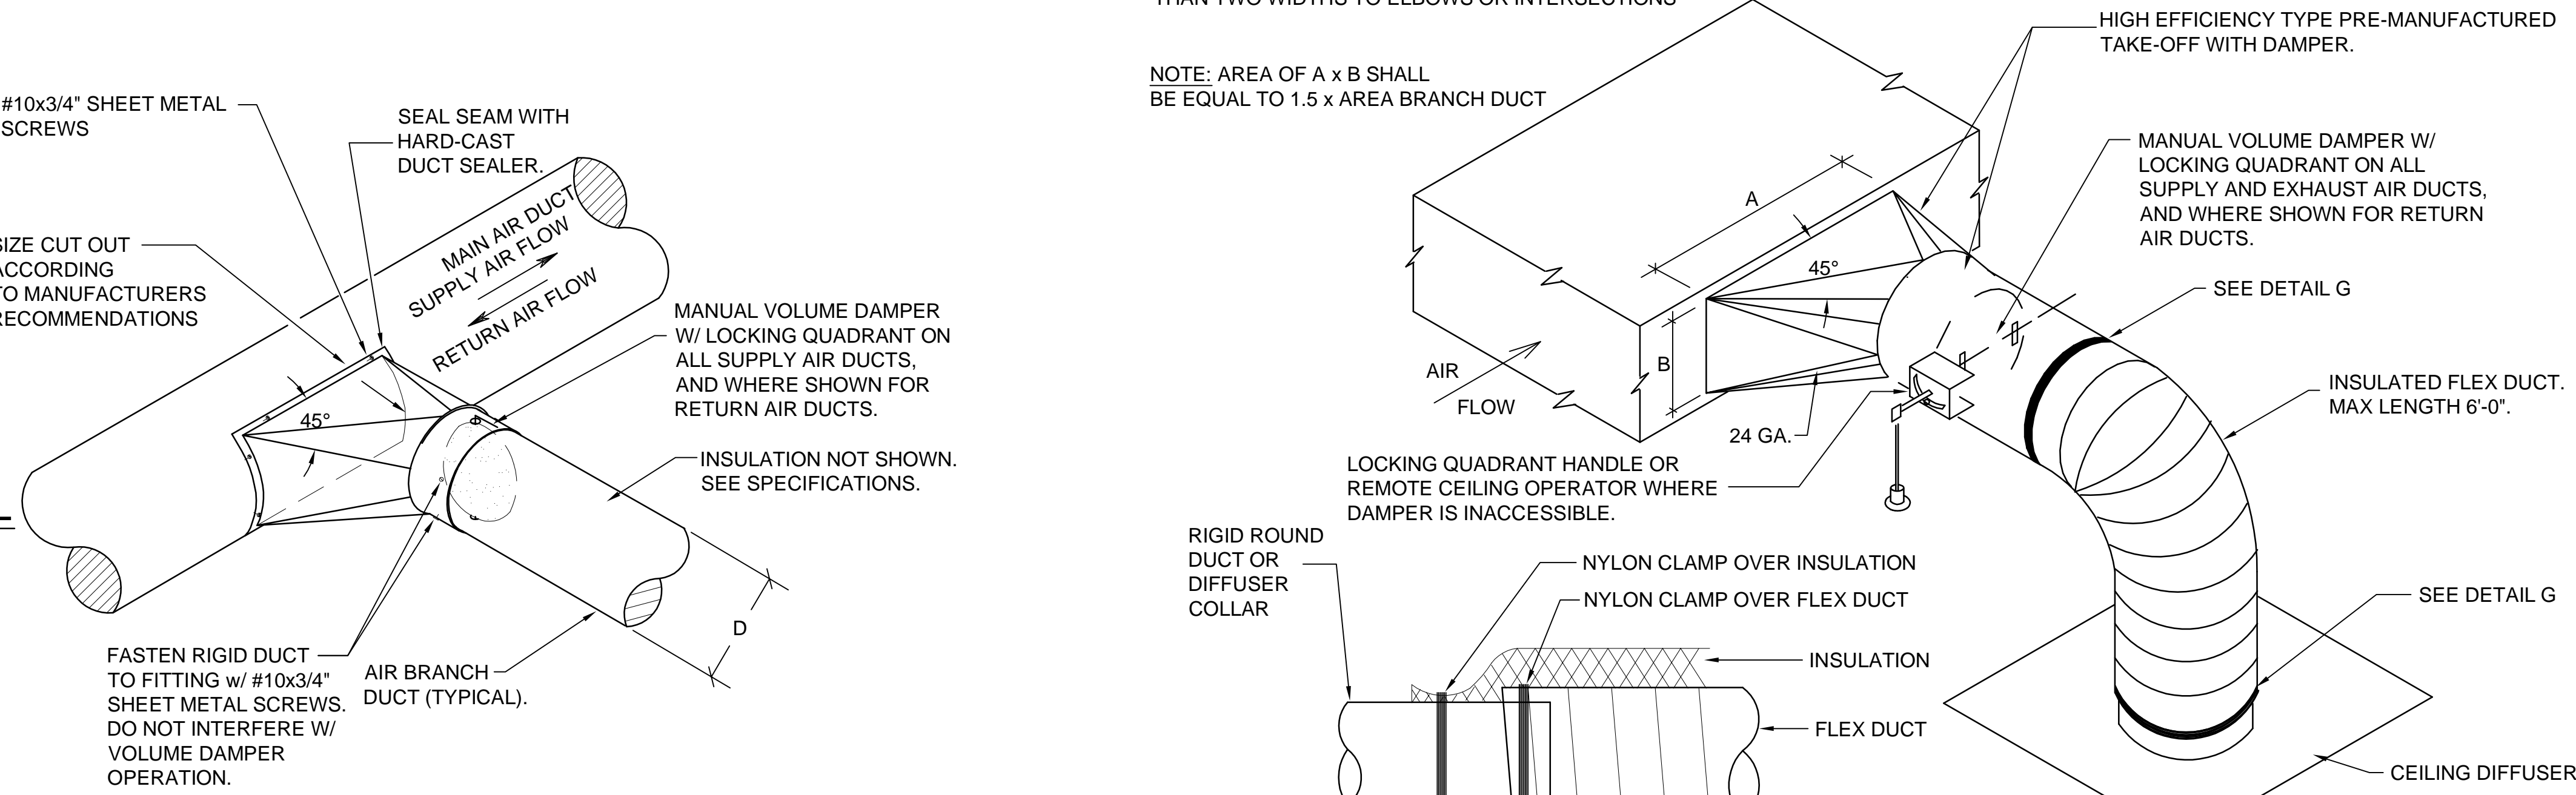


B3 ROUND-TO-ROUND DUCT CONSTRUCTION DETAIL
SCALE: NONE

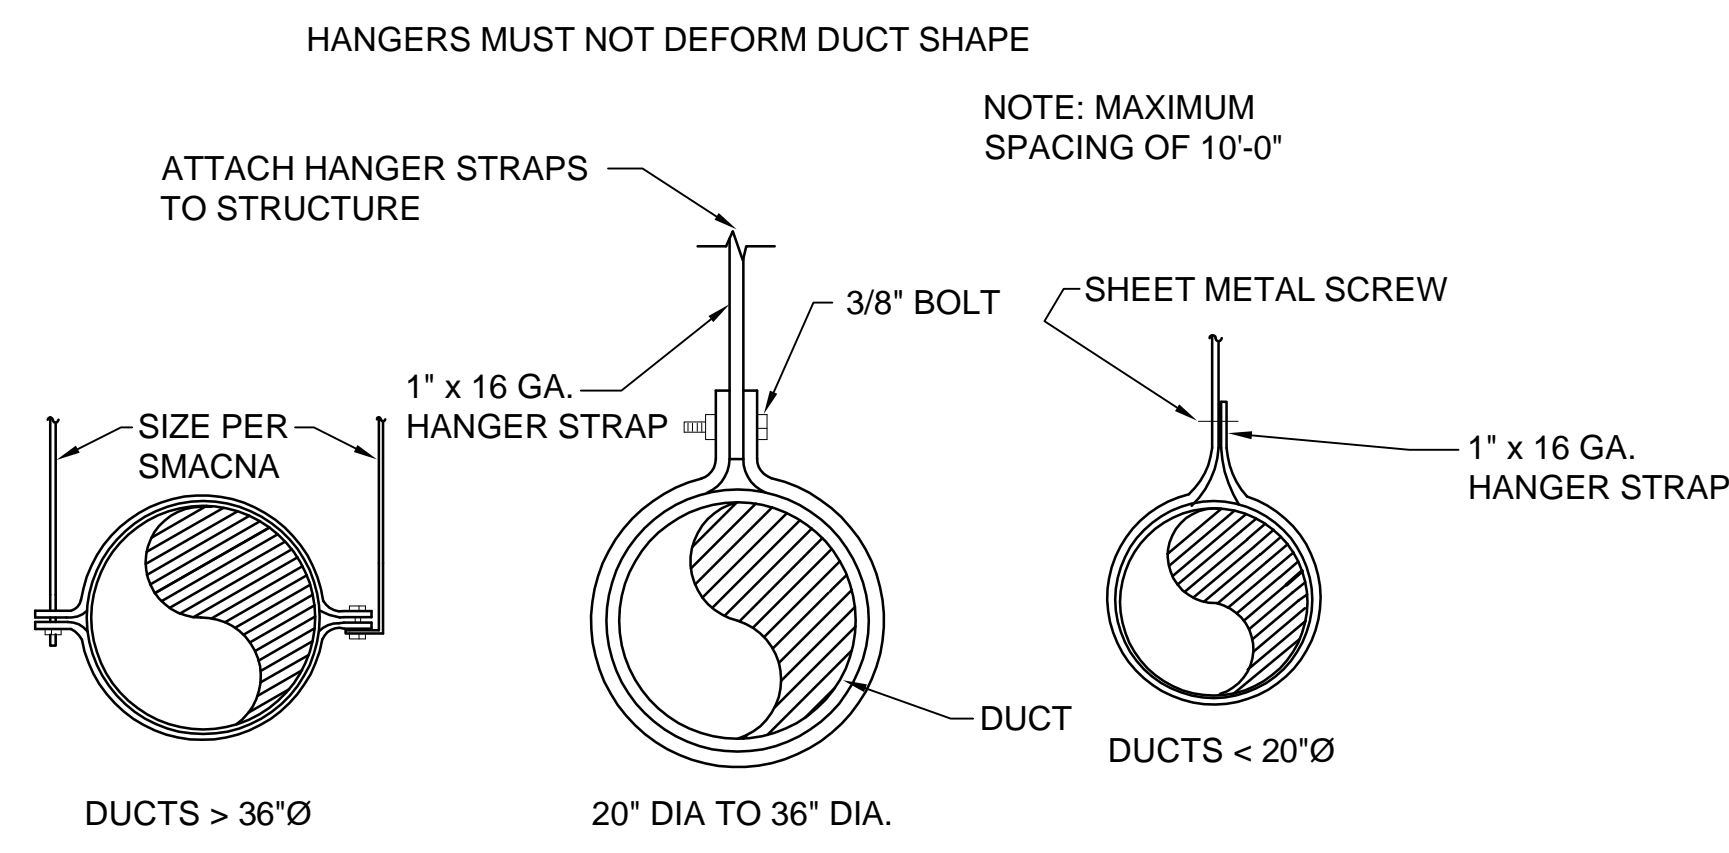

A1 ROUND DUCT SUPPORT DETAIL
SCALE: NONE

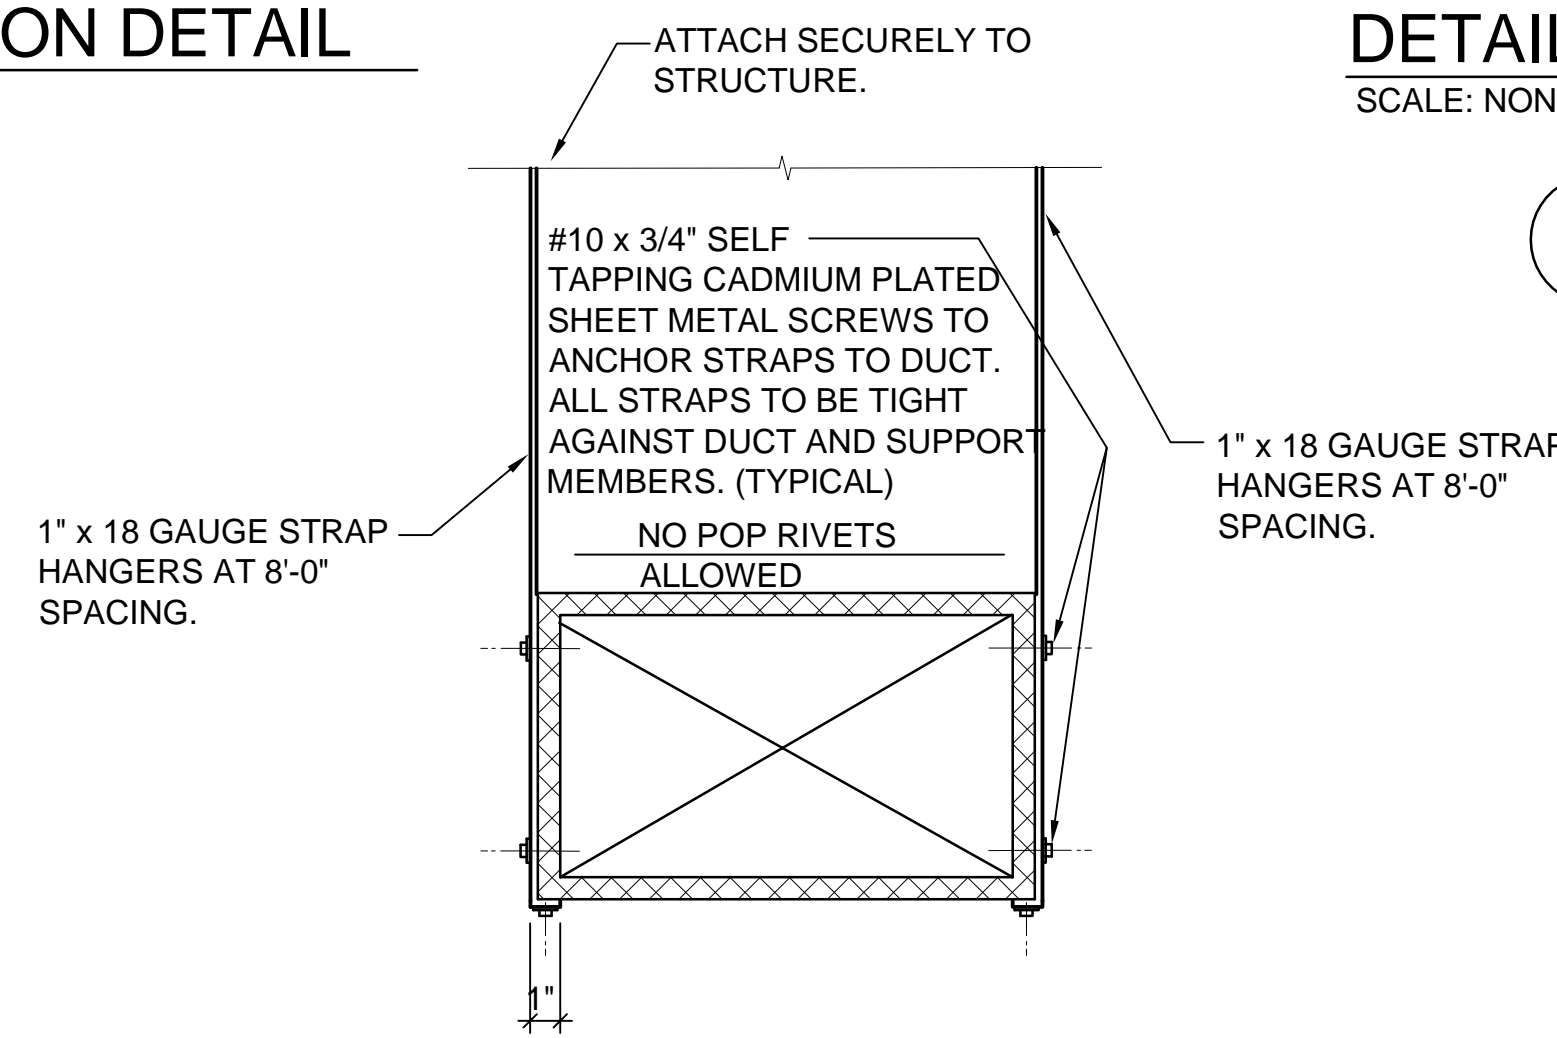

A3 DUCT STRAP HANGER DETAIL
SCALE: NONE

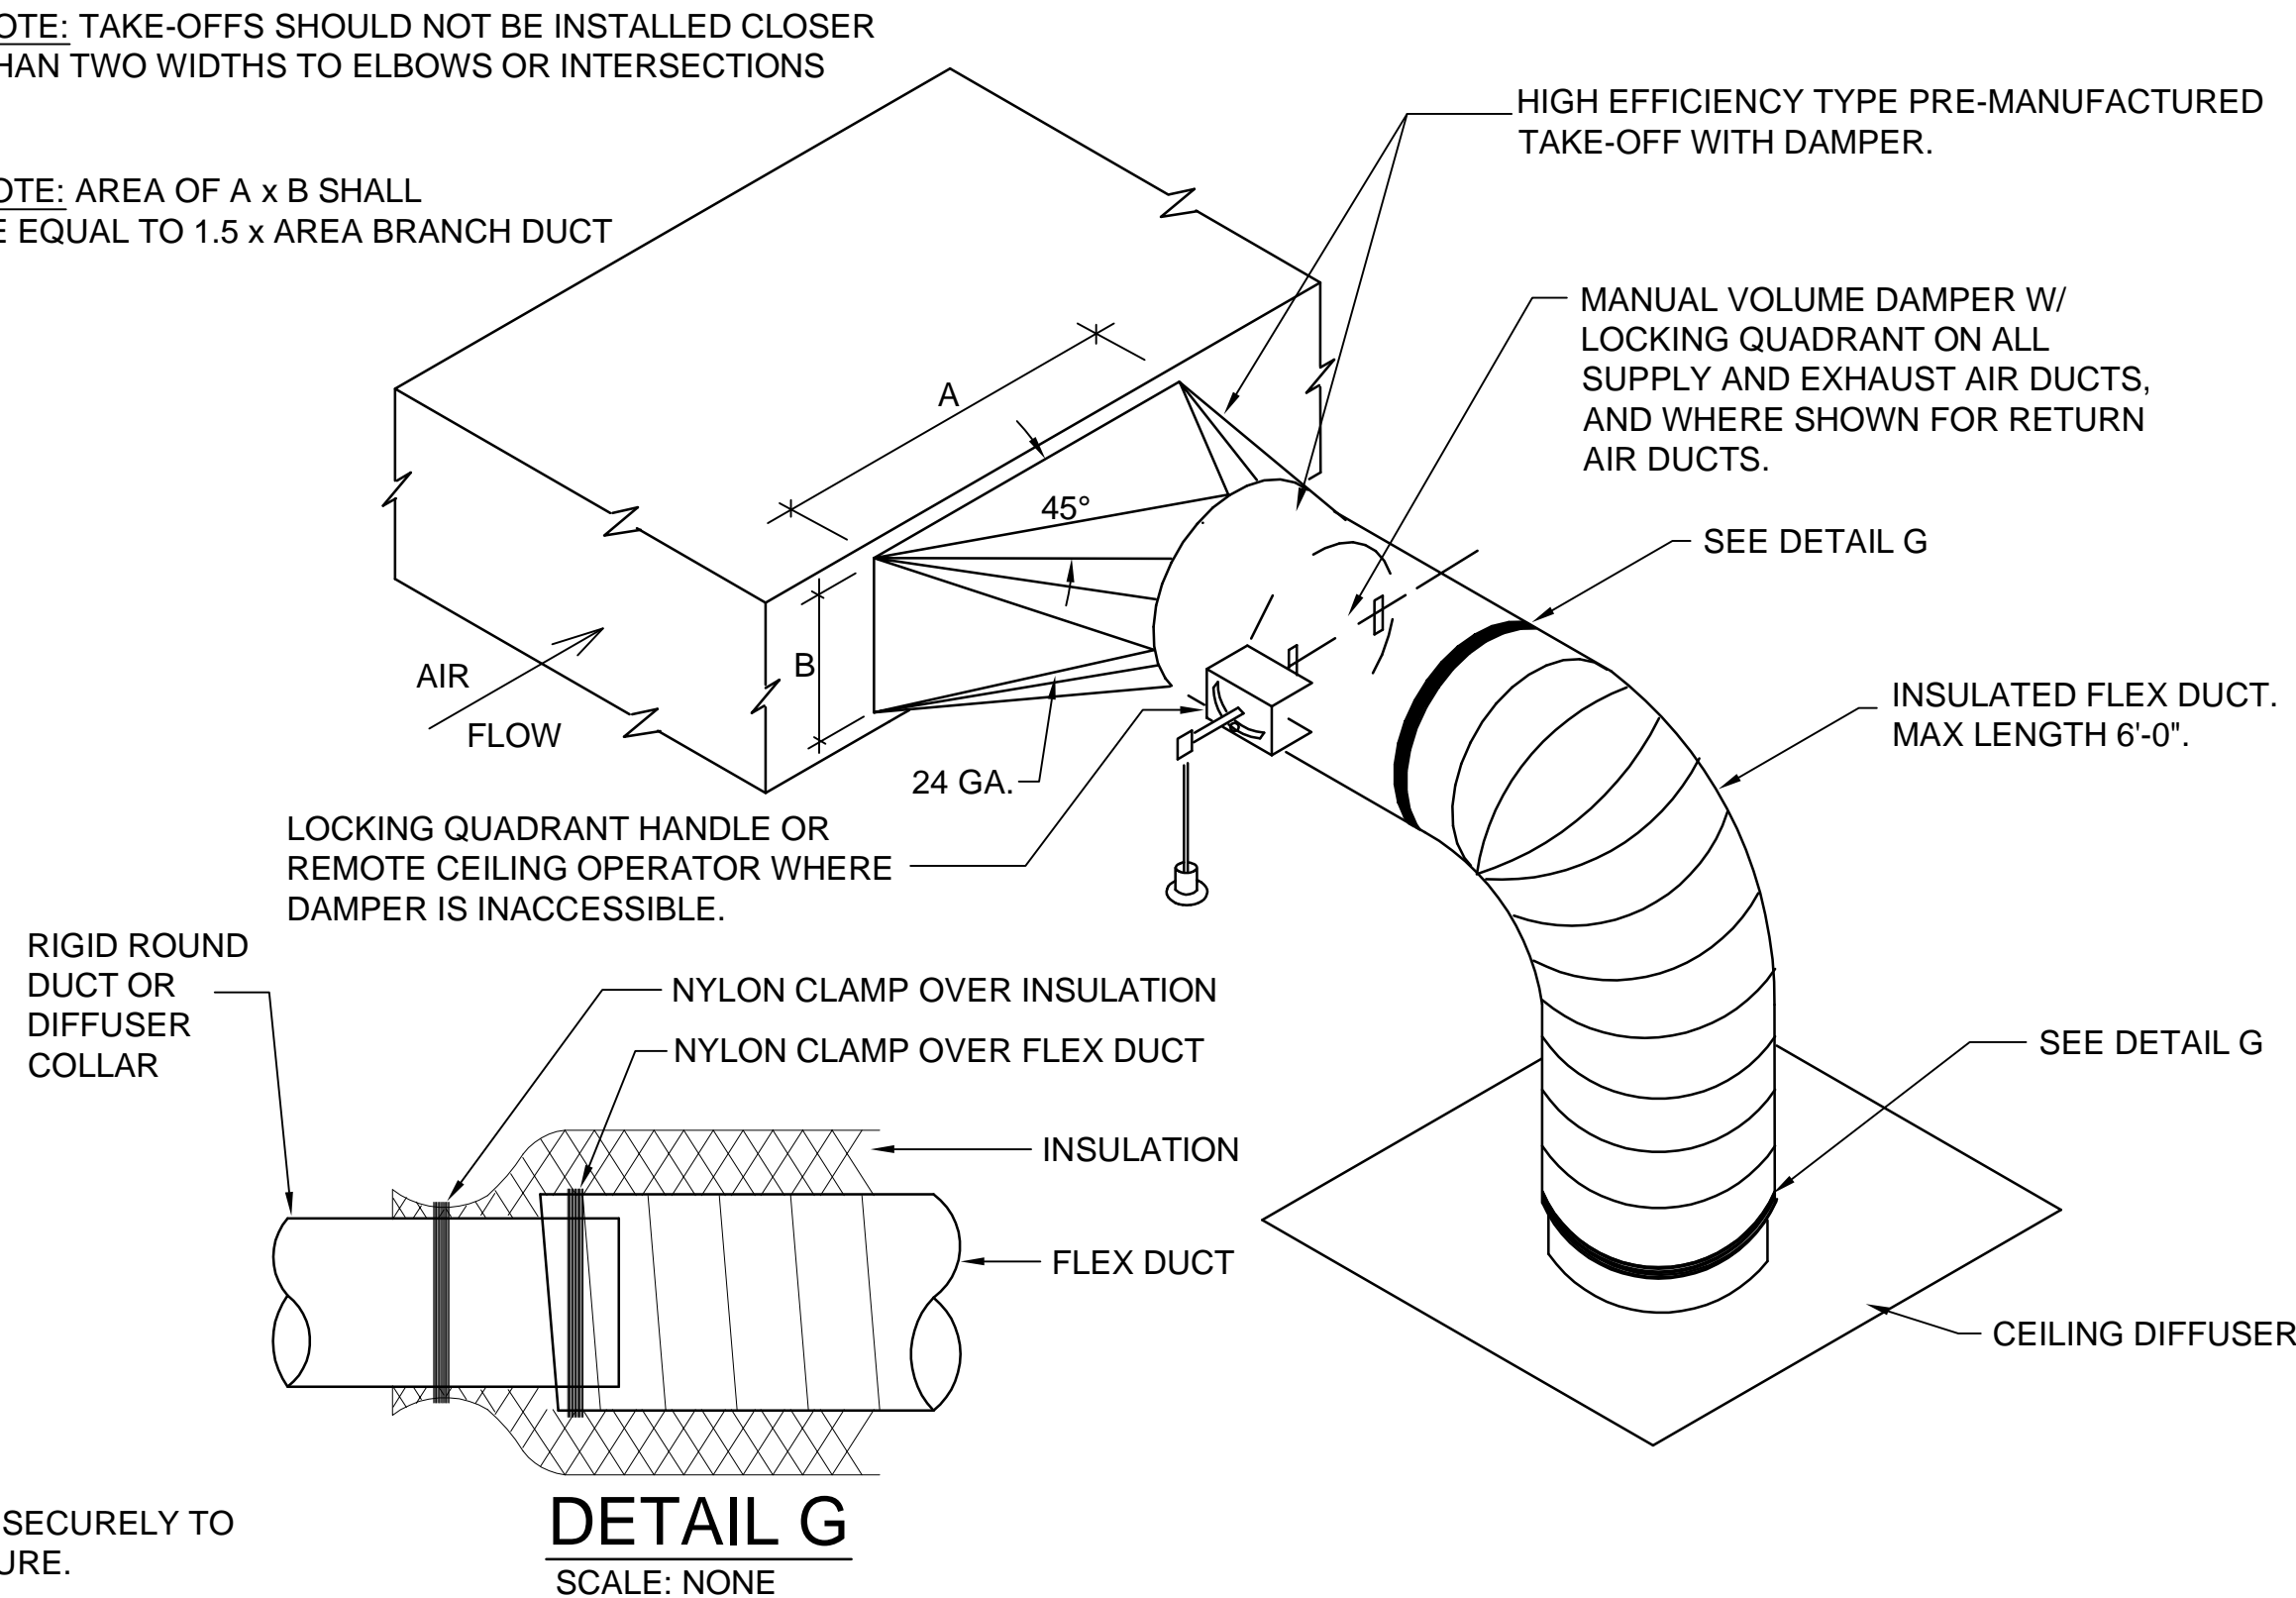

B5 SQUARE-TO-ROUND TAKE-OFF DETAIL
SCALE: NONE

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Department of Administrative Services

DFCM

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EMAIL: excellence@whw-engineering.com

PROJECT NAME & ADDRESS

DEPARTMENT OF SAFETY
RICHFIELD ITS UHP DISPATCH MODIFICATION

DFCM No. 06298550

Richfield, Utah 84701

MARK	DATE	REVISION

PROJECT MANAGER: WP

DRAWN BY: STAFF

CHECKED BY: SLW

DATE: 01/22/08

WHW JOB NO.: 06054

SHEET TITLE


MECHANICAL DETAILS

SHEET NO.

ME501

PROFESSIONAL ENGINEER
01/22/08
WINWARD M. PACKER
No. 375080
STATE OF UTAH

ME601

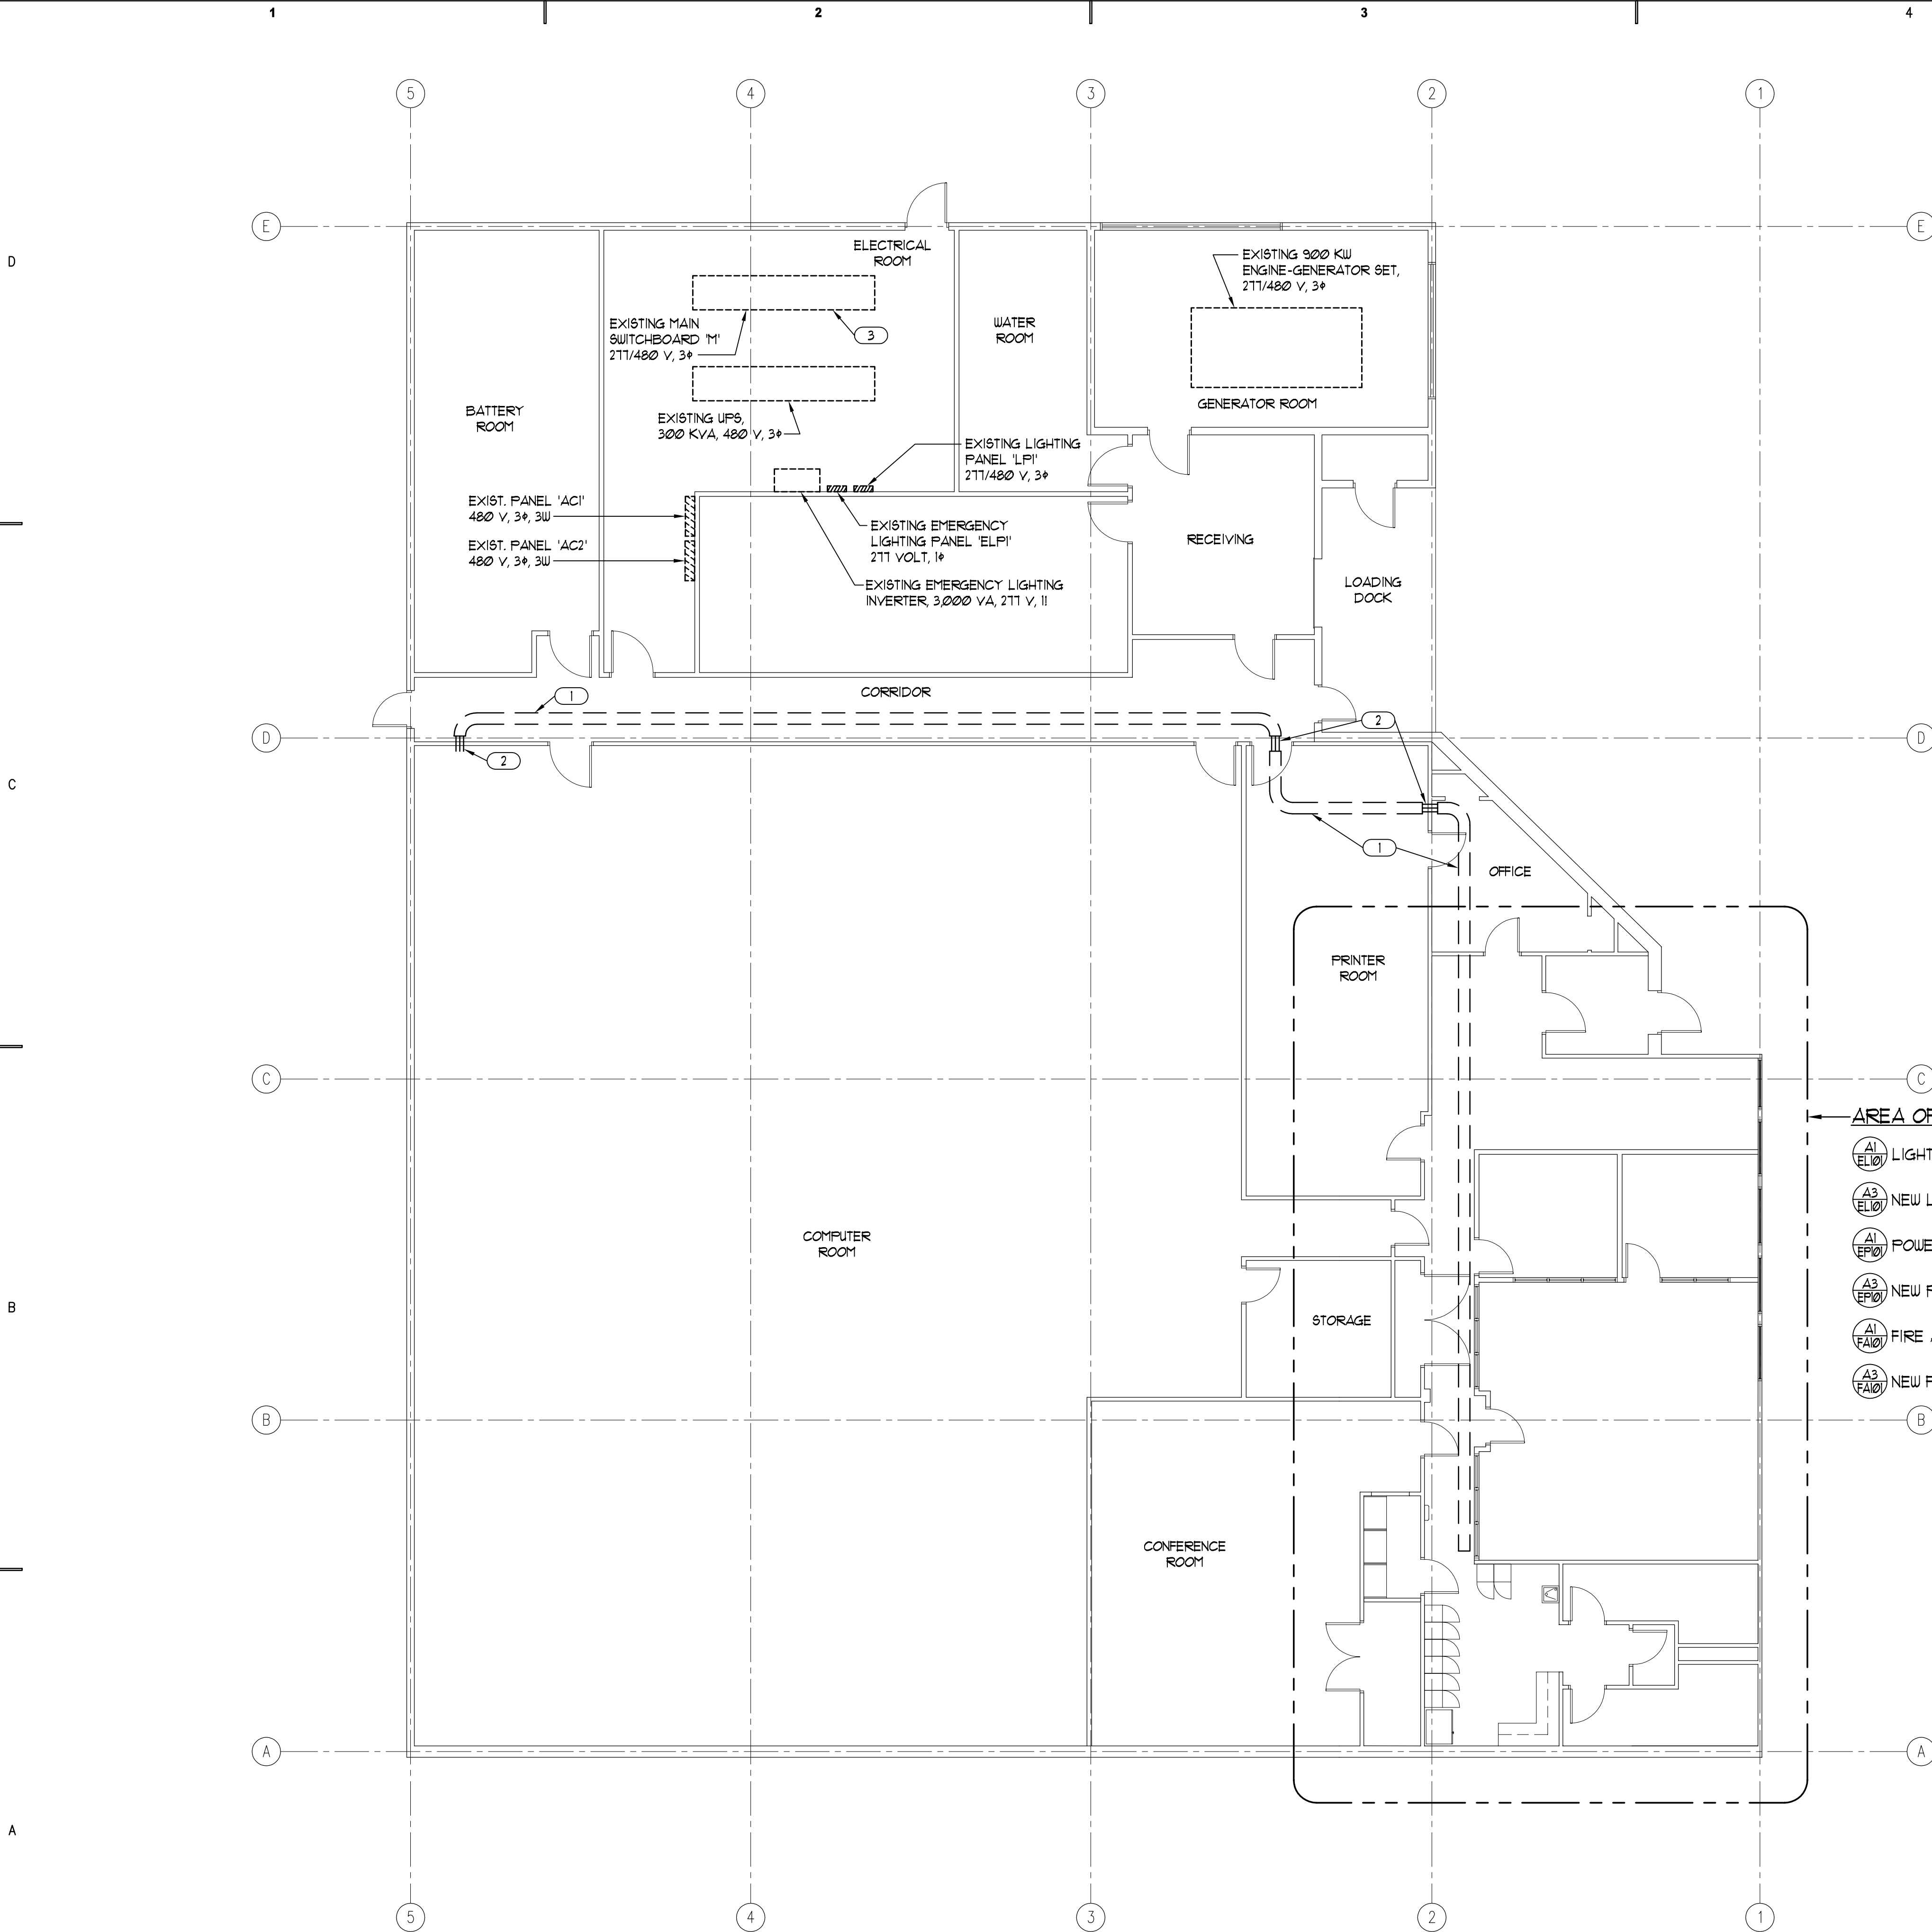

- GENERAL ELECTRICAL NOTES:**
1. LOCATIONS OF EXISTING ELECTRICAL EQUIPMENT, LIGHTING, SWITCHES, OUTLETS, BRANCH CIRCUIT WIRING, ETC., ARE BASED ON EXISTING BUILDING ELECTRICAL DRAWINGS AND FIELD OBSERVATION OF EXISTING SURFACE CONDITIONS. FIELD VERIFY EXISTING LOCATIONS AND CIRCUITING AND IMMEDIATELY NOTIFY THE ARCHITECT OF ANY DISCREPANCIES WHICH MAY ADVERSELY AFFECT COMPLETION OF THE WORK.
 2. DEMOLITION PLANS ARE SHOWN FOR CONTRACTORS REFERENCE ONLY. FIELD VERIFY QUANTITIES AND LOCATIONS OF ALL EXISTING MATERIAL AND EQUIPMENT TO BE REMOVED. REMOVE ALL ABANDONED WIRING, CONDUIT, BOXES, OUTLETS, FIXTURES, EQUIPMENT, ETC., WHETHER SPECIFICALLY SHOWN OR NOT.
 3. CONTRACTOR MAY USE EXISTING BRANCH CIRCUIT WIRING AND RACEWAYS WHERE CONVENIENT TO CONNECT TO NEW ELECTRICAL DEVICES ONLY IF THE EXISTING WIRING AND RACEWAYS ARE IN GOOD CONDITION AND MEET DIVISION 16 SPECIFICATION REQUIREMENTS FOR NEW WIRING AND RACEWAYS.
 4. WHERE REMOVAL OF EXISTING ELECTRICAL EQUIPMENT INTERRUPTS EXISTING BRANCH CIRCUITS OR FEEDERS TO EXISTING EQUIPMENT TO REMAIN, PROVIDE NEW CONDUIT AND WIRING AS REQUIRED TO RECONNECT THE EXISTING EQUIPMENT.
 5. ALL MATERIALS AND EQUIPMENT REMOVED SHALL REMAIN THE PROPERTY OF THE OWNER AND SHALL BE TURNED OVER TO THE OWNER FOR STORAGE OR BE DISPOSED OF BY THE CONTRACTOR AS DIRECTED BY THE OWNER.
 6. TAKE ALL PRECAUTIONS NECESSARY TO AVOID DAMAGE TO THE EXISTING BUILDING. REPAIR ALL DAMAGE INCURRED BY DEMOLITION AND NEW CONSTRUCTION TO EXACTLY MATCH SURROUNDING SURFACES AND/OR CONDITIONS WITHOUT ADDITIONAL COST TO THE OWNER. COORDINATE REPAIRS WITH THE GENERAL CONTRACTOR.

- KEYED NOTES:**
- 1 EXISTING 12" x 4" COMMUNICATION CABLE TRAY 11'-0"± ABOVE FLOOR (11'-0"± ABOVE CEILING WHERE OCCURS) TO REMAIN.
 - 2 EXISTING (3) 4" CONDUIT SLEEVES THROUGH FIRE RATED WALLS FOR COMMUNICATION CABLE TRAY TO REMAIN.
 - 3 PROVIDE NEW SIEMENS 3P-45A TYPE 'SHJD69045G' CIRCUIT BREAKER WITH GROUND FAULT PROTECTION AND ADJUSTABLE SOLID STATE TRIP, AND NECESSARY MOUNTING HARDWARE IN EXISTING MAIN SWITCHBOARD 'M1' TO SERVE NEW ROOFTOP UNIT RTU/2. PROVIDE NEW ENGRAVED NAMEPLATE TO IDENTIFY LOAD SERVED BY NEW BREAKER.

ELECTRICAL REFERENCE PLAN
SCALE: 1/8" = 1'-0"
NORTH

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Department of Administrative Services

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Thomas and Kolkman Engineering Co. Inc.
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Salt Lake City, Utah 84115
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PROJECT NAME & ADDRESS

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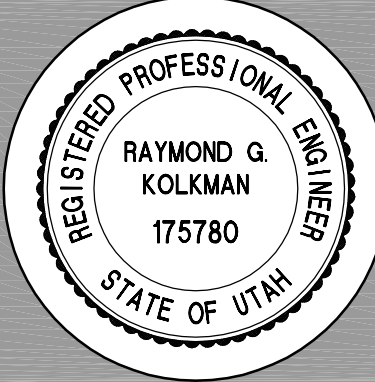
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W.B.G.

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R.G.K.

DATE:
09/24/07


WHW JOB NO.:
06054

SHEET TITLE



**ELECTRICAL PLANS
AND SCHEDULES**


SHEET NO.
E-101

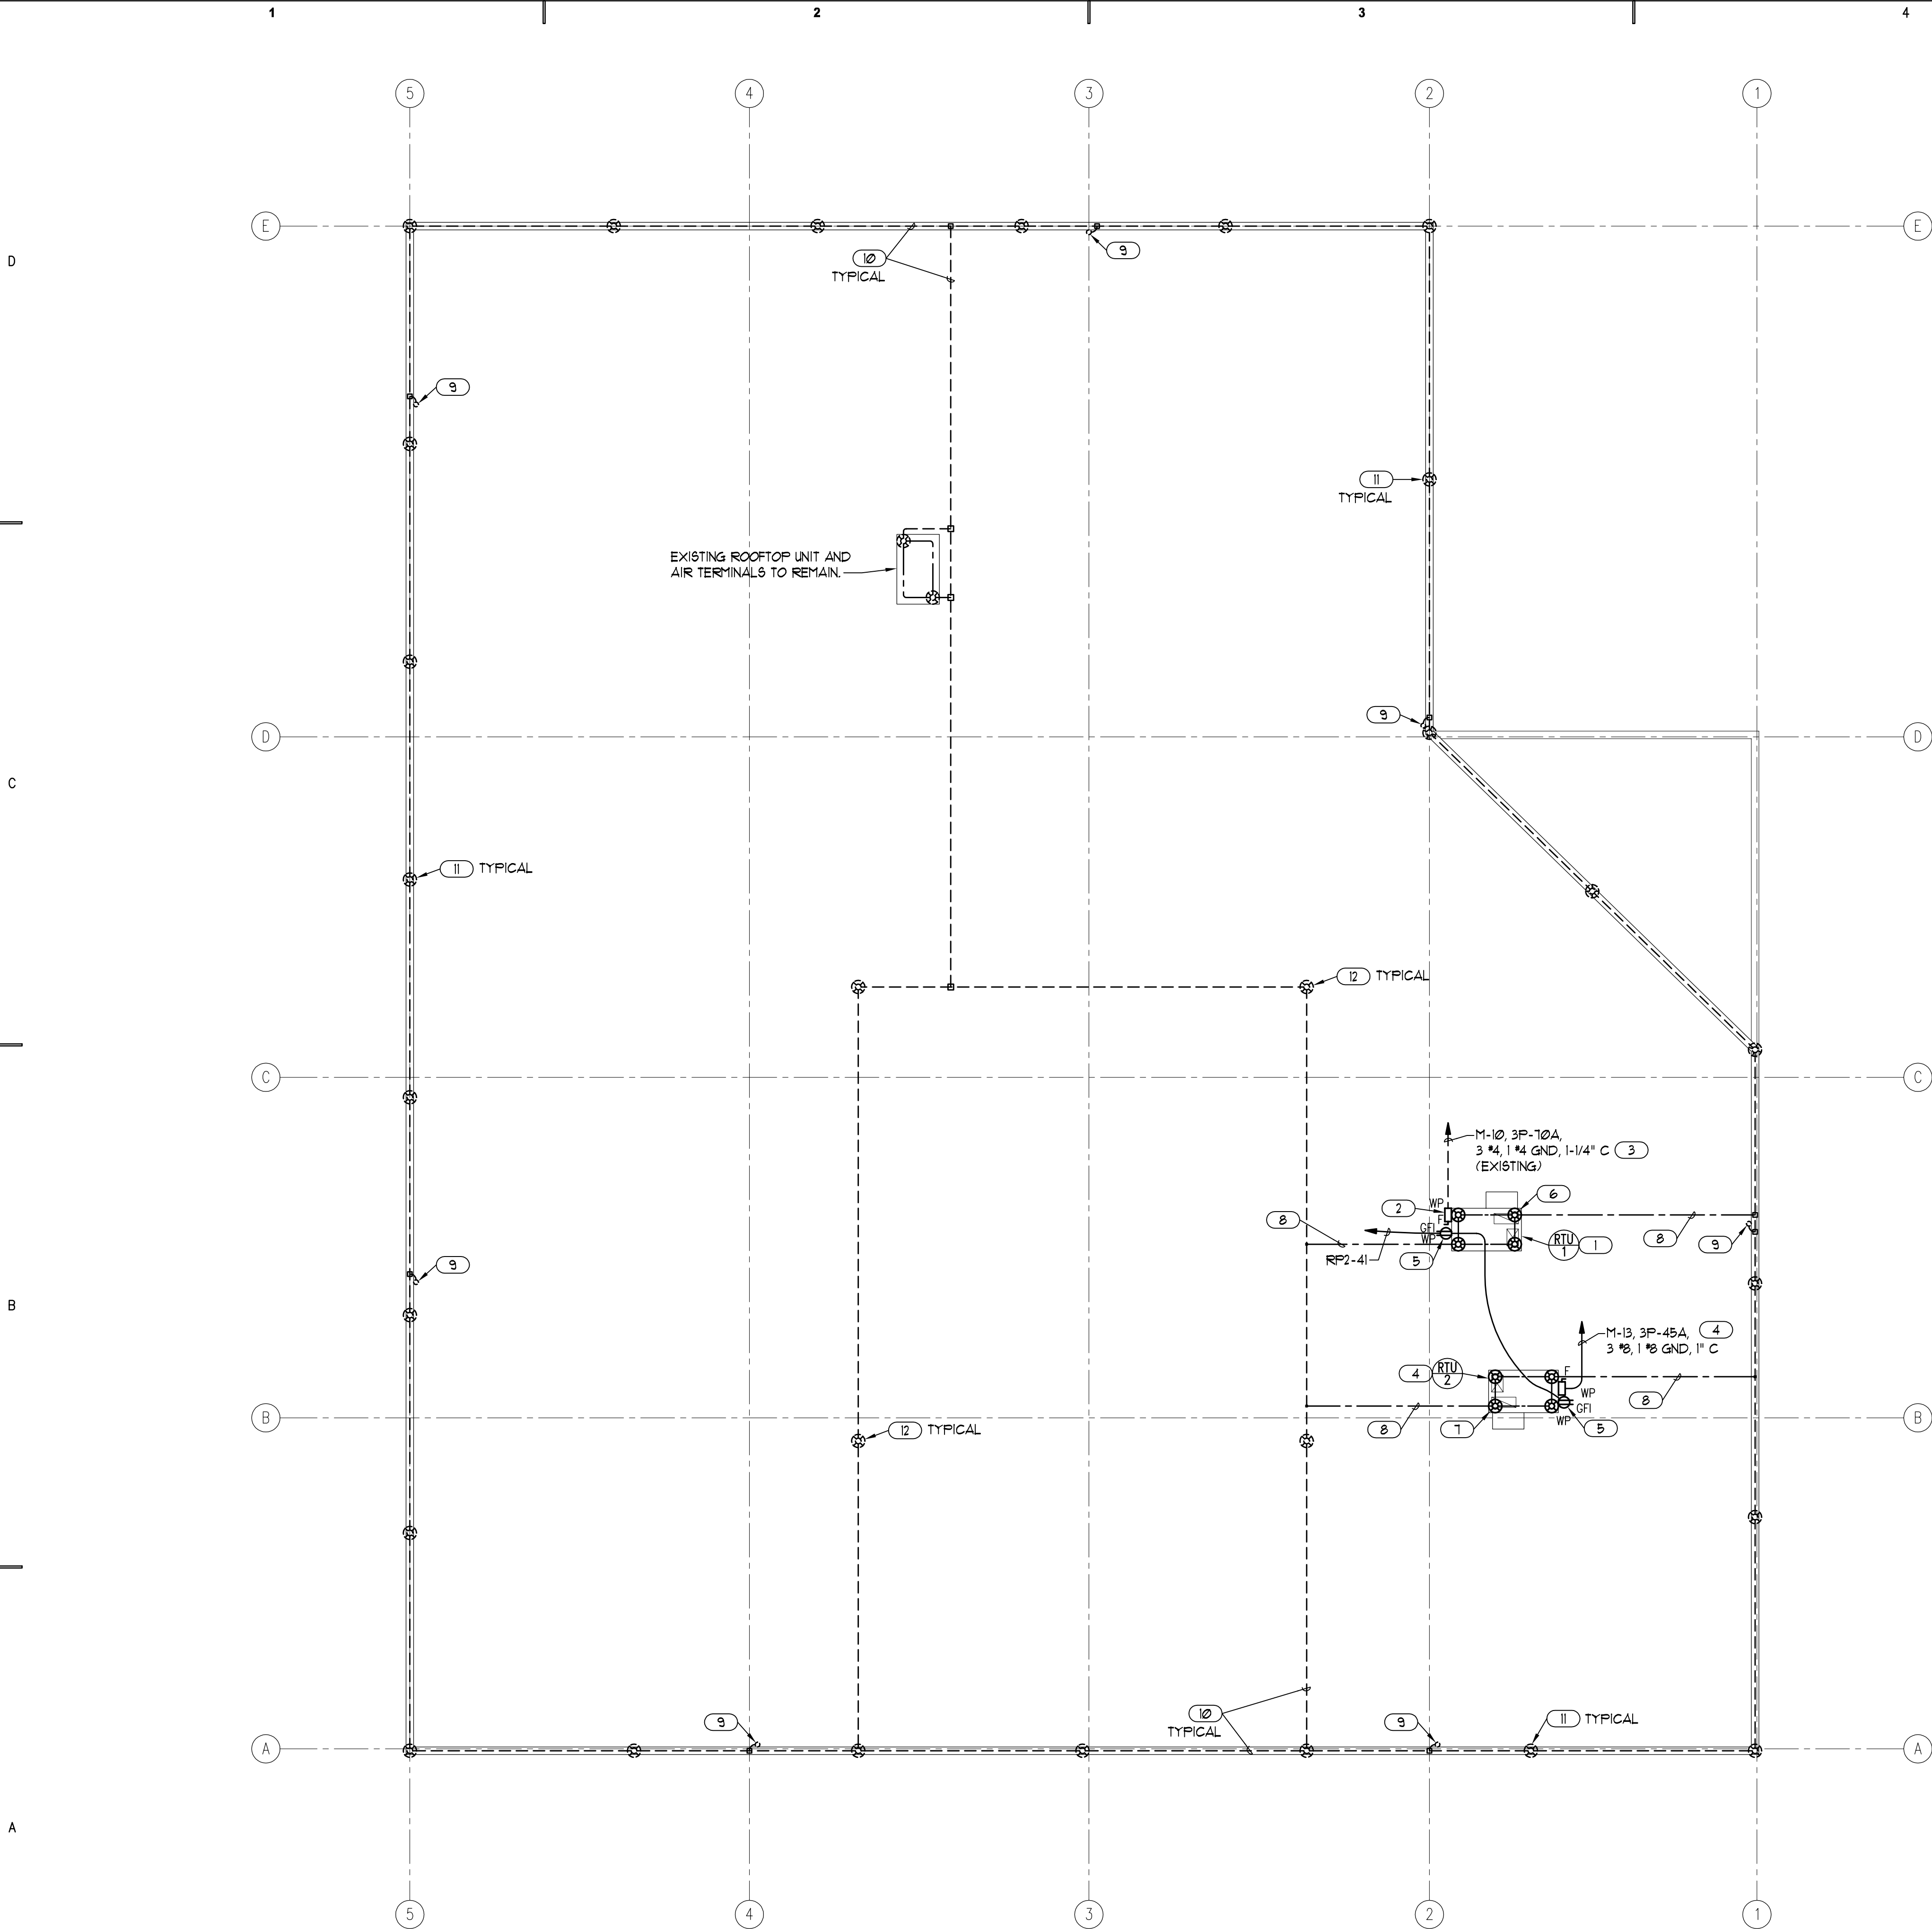

- GENERAL NOTES:**
- SEE GENERAL ELECTRICAL NOTES, SHEET E-101.
 - ADDITIONS AND MODIFICATIONS TO THE EXISTING BUILDING LIGHTNING PROTECTION SYSTEM SHALL BE INSTALLED UNDER THE SUPERVISION OF A UL CERTIFIED LIGHTNING PROTECTION SYSTEM INSTALLER WHO WILL BE RESPONSIBLE FOR DETERMINING FINAL LOCATIONS AND QUANTITY OF AIR TERMINALS, BONDING REQUIREMENTS, ETC., TO PROVIDE A COMPLETE LIGHTNING PROTECTION SYSTEM IN ACCORDANCE WITH NFPA 780-2004, STANDARD FOR THE INSTALLATION OF LIGHTNING PROTECTION SYSTEMS.
 - EXISTING AIR TERMINALS AND BONDING CONNECTIONS TO EXISTING ROOFTOP EQUIPMENT NOT SHOWN ARE TO REMAIN.
 - ADHESIVE USED WITH ADHESIVE TYPE AIR TERMINAL BASES AND ROOF CONDUCTOR FASTENERS SHALL BE COMPATIBLE WITH THE EXISTING ROOFING MEMBRANE, VERIFY WITH ROOFING CONTRACTOR PRIOR TO INSTALLATION.

- KEYED NOTES:**
- NEW ROOFTOP UNIT RTU/1 TO REPLACE EXISTING ROOFTOP UNIT. SEE MECHANICAL PLANS.
 - REMOVE EXISTING SAFETY SWITCH FOR EXISTING ROOFTOP UNIT TO BE REMOVED. PROVIDE NEW 3P-60A SAFETY SWITCH WITH 50 AMPERE FUSES, OR FUSE RATING AS REQUIRED TO MATCH "MAXIMUM OVERCURRENT PROTECTION" RATING ON NEW ROOFTOP UNIT NAMEPLATE.
 - EXISTING FEEDER TO REMAIN FROM MAIN SWITCHBOARD 1" TO EXISTING ROOFTOP UNIT. RECONNECT TO NEW FUSED SAFETY SWITCH AS INDICATED.
 - NEW ROOFTOP UNIT, SEE MECHANICAL PLANS. PROVIDE COMPLETE NEW ELECTRICAL SERVICE AS INDICATED.
 - REPLACE 15 AMPERE RECEPTACLES FURNISHED WITH NEW ROOFTOP UNITS WITH NEW 20 AMPERE (NEMA 5-20) GFCI RECEPTACLES AND CONNECT TO NEW CIRCUIT AS INDICATED. REPLACE FLIP LID WEATHERPROOF RECEPTACLE COVERS WITH NEW "RAINTIGHT WHILE IN USE" RECEPTACLE COVERS.
 - RELOCATE EXISTING 1/2" x 12" HIGH AIR TERMINALS FROM EXISTING ROOFTOP UNIT TO NEW ROOFTOP UNIT RTU/1. PROVIDE NEW ROOF CONDUCTORS AS REQUIRED TO RECONNECT TO EXISTING ROOF CONDUCTORS AS INDICATED.
 - PROVIDE NEW 1/2" x 12" HIGH AIR TERMINALS ON NEW ROOFTOP UNIT RTU/2. COMPLETE NEW ROOF CONDUCTORS AND CONNECTIONS TO EXISTING ROOF CONDUCTORS AS INDICATED.
 - NEW 28 STRANDS OF 14 GAUGE BARE ALUMINUM BRAIDED CABLE, EXPOSED ON ROOF OR ROOFTOP EQUIPMENT AS SHOWN. SECURE WITH ADHESIVE TYPE CABLE HOLDERS AT 3'-0" ON CENTER.
 - EXISTING LIGHTNING PROTECTION SYSTEM CONCEALED DOWN CONDUCTOR TO GROUND GRID TO REMAIN.
 - EXISTING 28 STRANDS OF 14 GAUGE BARE ALUMINUM BRAIDED ROOF CONDUCTORS, EXPOSED ON EXISTING ROOF TO REMAIN.
 - EXISTING 1/2" x 12" ALUMINUM ROOF PERIMETER AIR TERMINALS TO REMAIN.
 - EXISTING 1/2" x 24" ALUMINUM ROOF AIR TERMINALS TO REMAIN.

ROOF ELECTRICAL PLAN
SCALE: 1/8" = 1'-0"

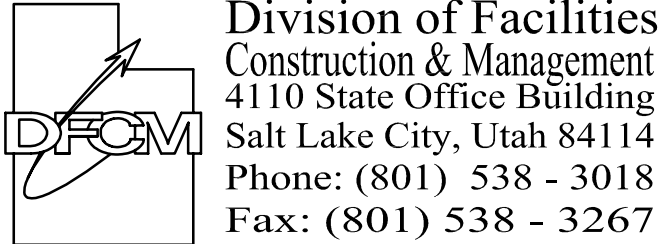


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PROJECT NAME & ADDRESS

**DEPARTMENT OF
SAFETY
RICHFIELD ITS UHP
DISPATCH
MODIFICATION**

DFCM No. 06298550

Richfield, Utah 84701

MARK	DATE	REVISION

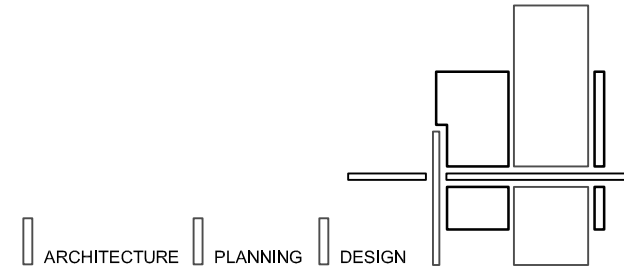PROJECT MANAGER:

WP

DRAWN BY:

W.B.G.

CHECKED BY:

R.G.K.

DATE:

09/24/07

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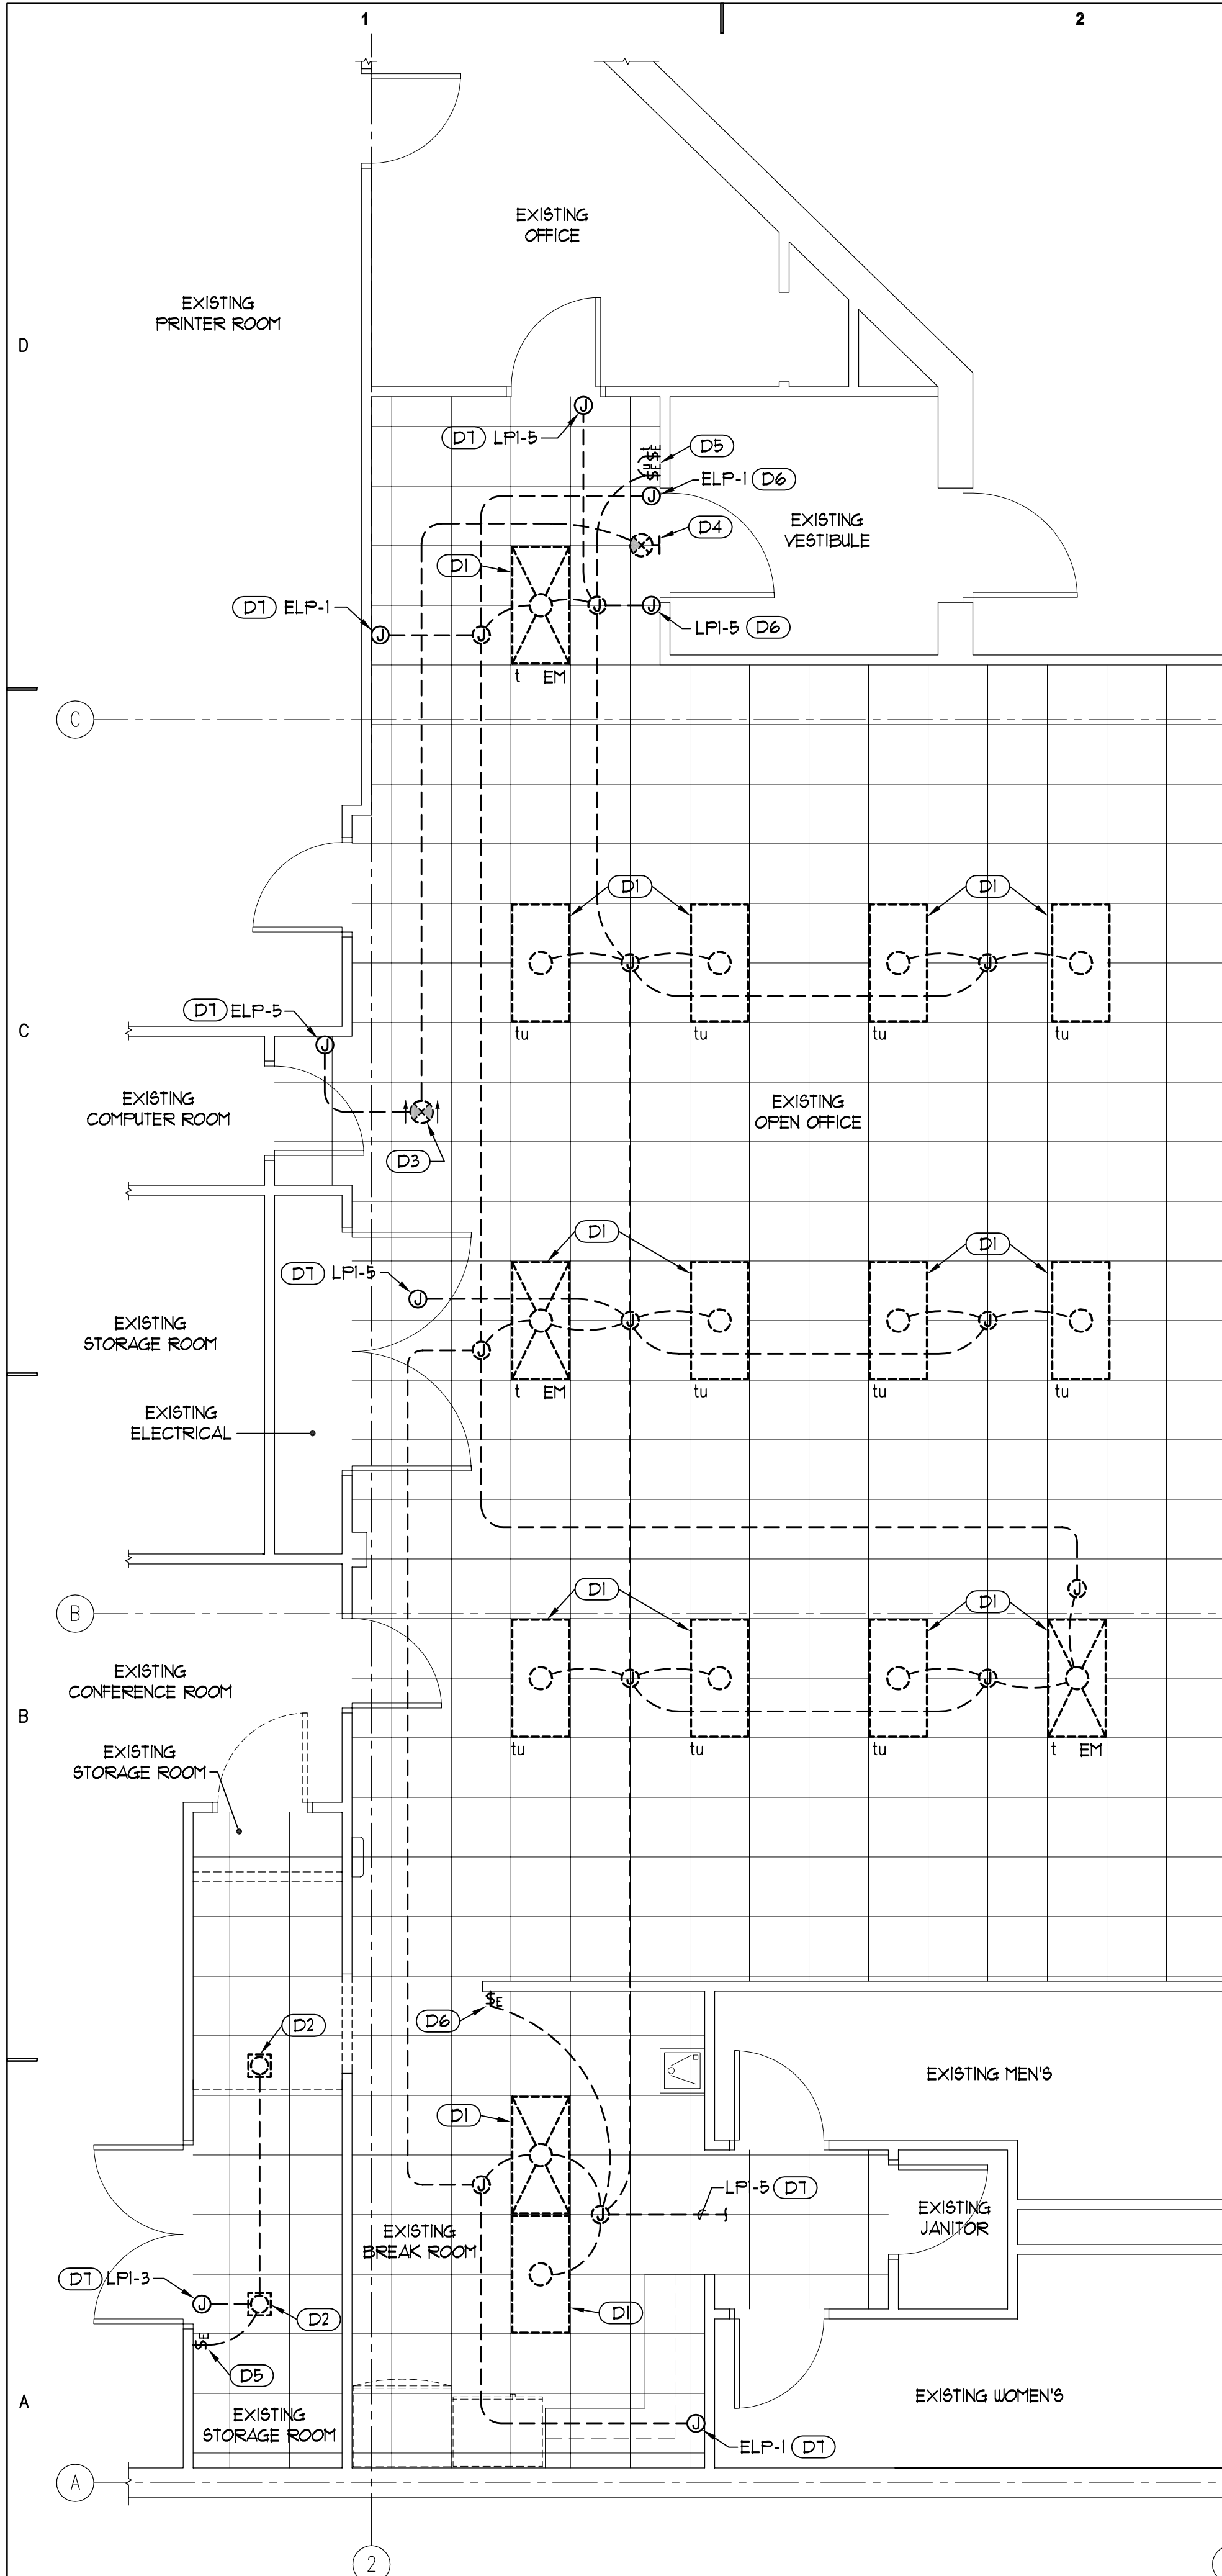
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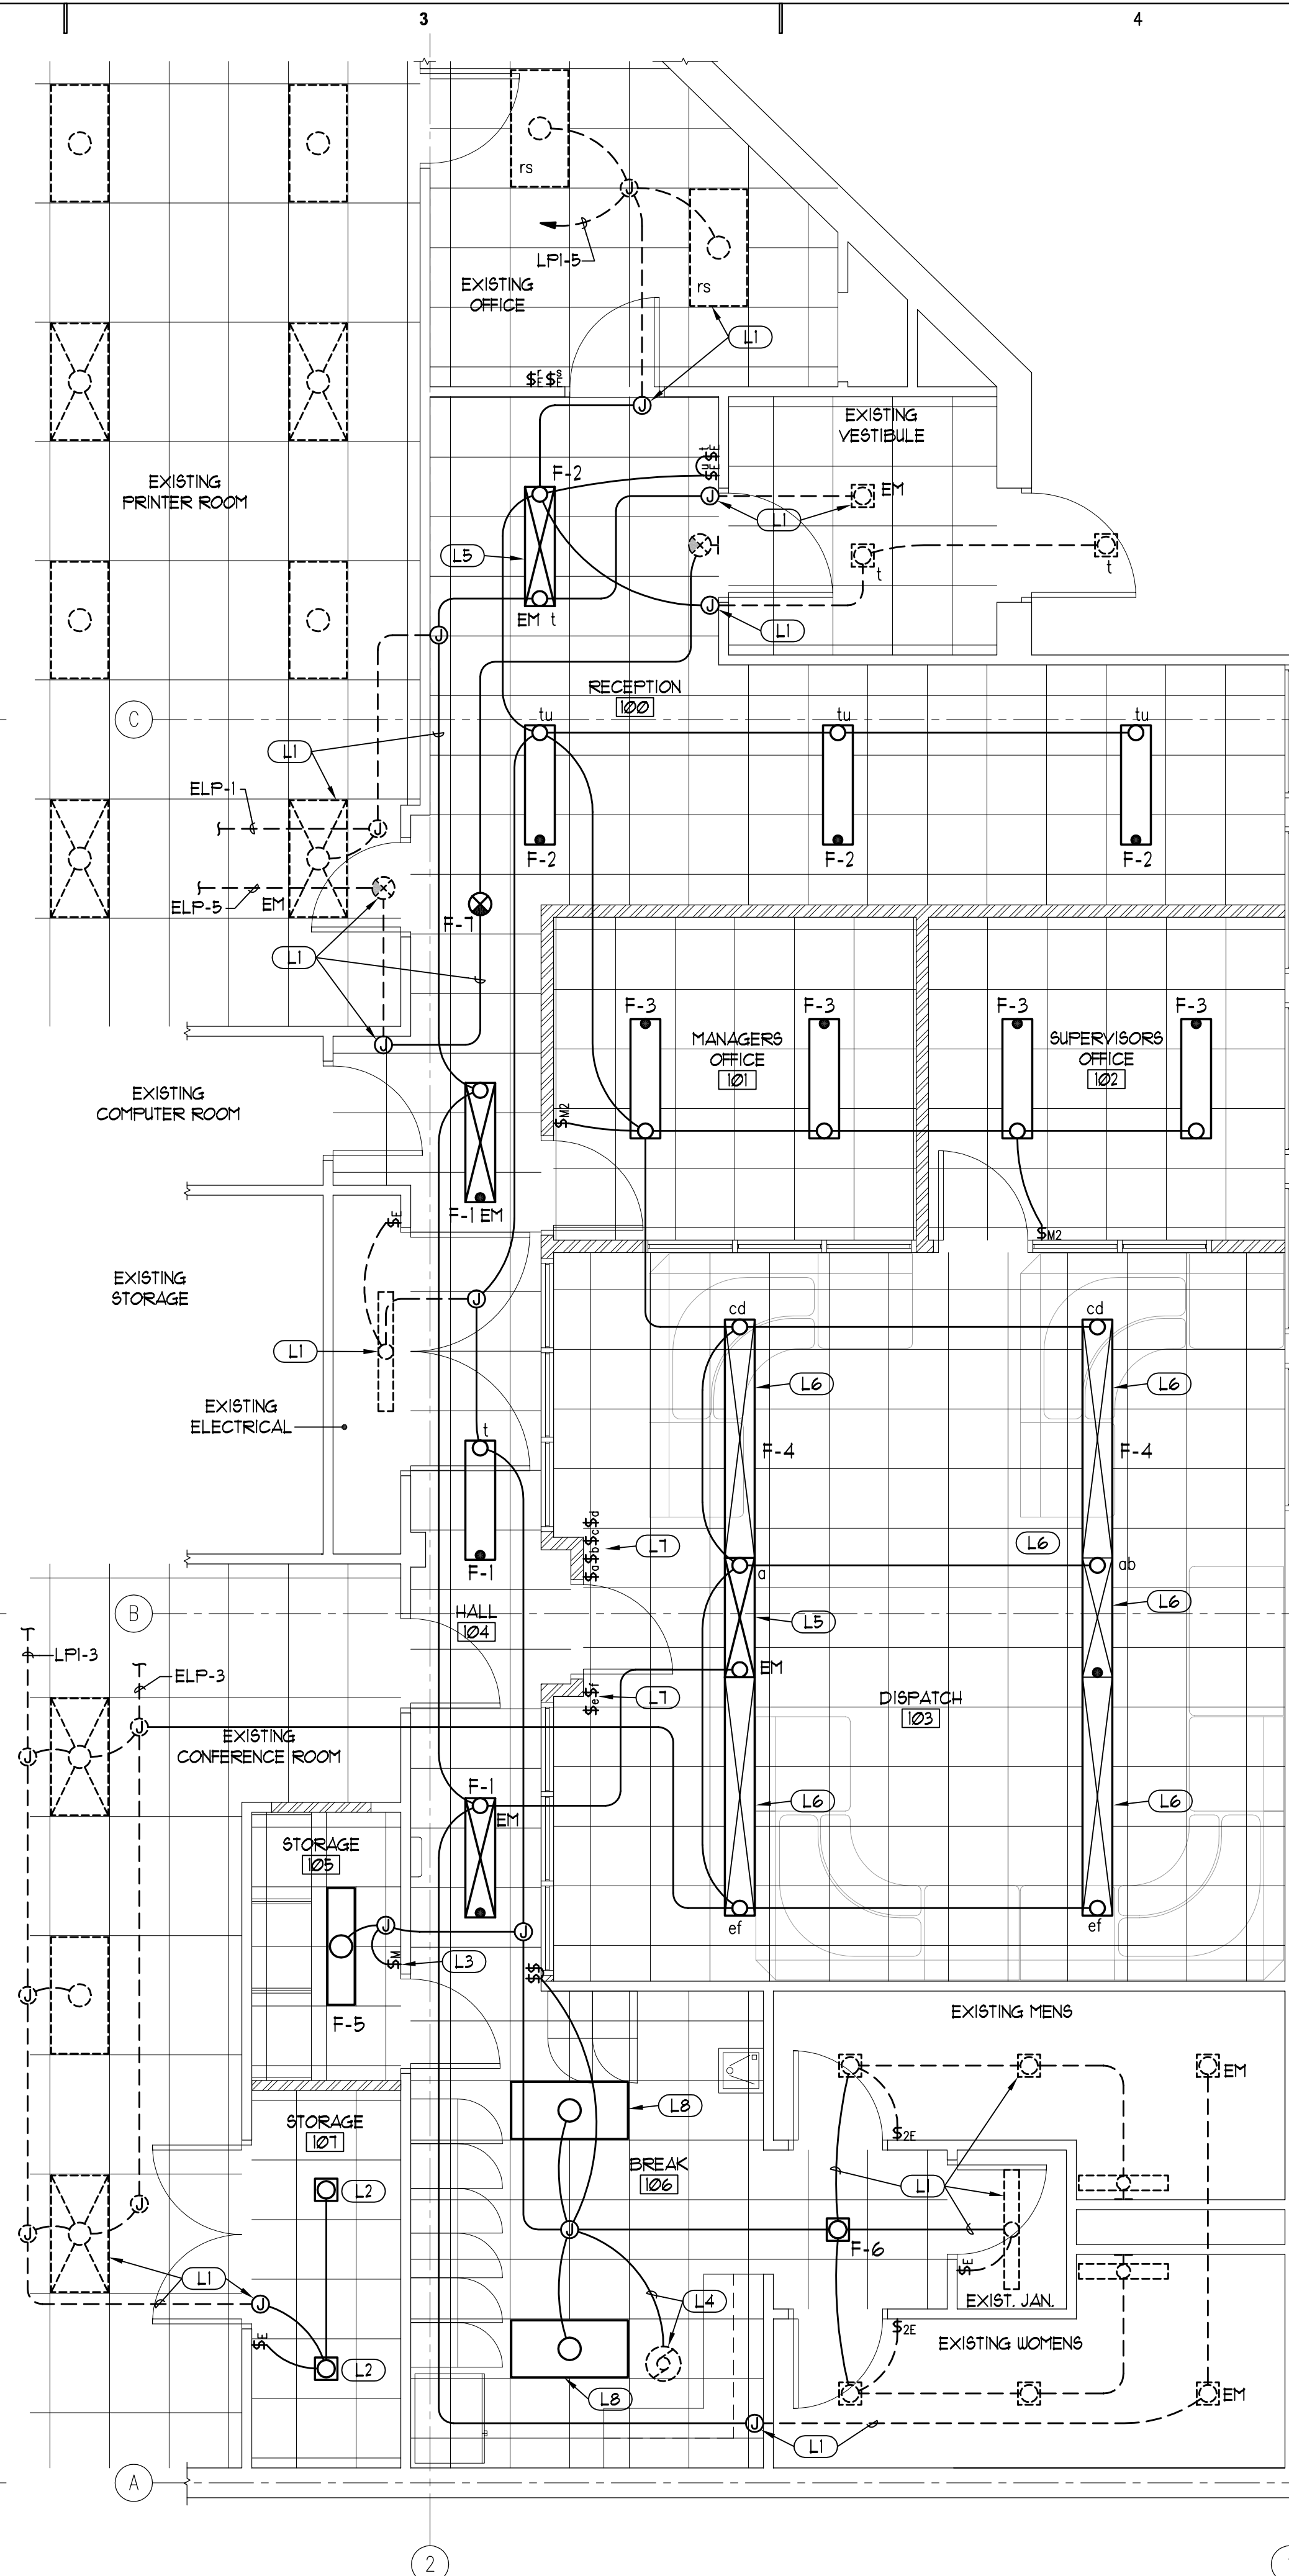
ROOF ELECTRICAL PLAN

SHEET NO.

E-102



A1 LIGHTING DEMOLITON PLAN
SCALE: 1/4" = 1'-0"



A3 NEW LIGHTING PLAN
SCALE: 1/4" = 1'-0"

GENERAL NOTES:

- SEE GENERAL ELECTRICAL NOTES, SHEET E-101.
- COORDINATE FIXTURE LOCATIONS WITH ARCHITECT'S REFLECTED CEILING PLAN, CEILING CONTRACTOR, BUILDING STRUCTURE, MECHANICAL EQUIPMENT & DUCTWORK LOCATIONS, ETC.
- TAKE ALL PRECAUTIONS NECESSARY TO AVOID DAMAGE TO THE EXISTING BUILDING. REPAIR ALL DAMAGE INCURRED BY DEMOLITION AND NEW CONSTRUCTION TO EXACTLY MATCH SURROUNDING SURFACES AND/OR CONDITIONS WITHOUT ADDITIONAL COST TO THE OWNER. COORDINATE REPAIRS WITH THE GENERAL CONTRACTOR.

LIGHTING DEMOLITON PLAN KEYED NOTES:

- REMOVE EXISTING 2' x 4', 3 LAMP, FLOURESCENT PARABOLIC TROFFER INCLUDING ALL ABANDONED WIRING, CONDUIT, BOXES, SUPPORTS, ETC. SALVAGE 2 EXISTING FIXTURES IN GOOD CONDITION FOR RELOCATION TO BREAK ROOM AS SHOWN ON NEW LIGHTING PLAN.
- REMOVE EXISTING RECESSED COMPACT FLOURESCENT DOWNLIGHT INCLUDING ALL ABANDONED WIRING, CONDUIT, BOXES, ETC. SALVAGE EXISTING FIXTURE FOR RELOCATION TO NEW CEILING AS SHOWN ON NEW LIGHTING PLAN.
- REMOVE EXISTING CEILING MOUNTED EXIT LIGHT INCLUDING ALL ABANDONED WIRING, CONDUIT, BOXES, ETC.
- EXISTING WALL MOUNTED LED EXIT LIGHT TO REMAIN. RECONNECT EXISTING CIRCUIT AS SHOWN ON NEW LIGHTING PLAN.
- EXISTING SWITCHES TO REMAIN. RECONNECT TO CONTROL NEW FIXTURES AS SHOWN ON NEW LIGHTING PLAN.
- REMOVE EXISTING SWITCH COMPLETE INCLUDING OUTLET BOX, WIRING, ACCESSIBLE CONDUIT, ETC. REPAIR EXISTING WALL AS REQUIRED TO ALLOW FOR INSTALLATION OF NEW LOCKERS, SEE ARCHITECT'S PLANS.
- INTERCEPT EXISTING BRANCH CIRCUIT TO ADJACENT ROOMS IN NEW JUNCTION BOX AS REQUIRED TO RECONNECT EXISTING CIRCUITS AS SHOWN ON NEW LIGHTING PLAN.

NEW LIGHTING PLAN KEYED NOTES:

- EXISTING LIGHTING, CIRCUIT, SWITCHES, ETC., IN ADJACENT ROOMS TO REMAIN. EXTEND AND RECONNECT EXISTING BRANCH CIRCUITS AS INDICATED.
- INSTALL RECESSED COMPACT FLOURESCENT FIXTURE SALVAGED FROM DEMOLITION. RECONNECT EXISTING SWITCH AND CIRCUIT AS INDICATED. CLEAN FIXTURE, RELAMP WITH 2 NEW F32T/35K LAMPS, AND LEAVE IN PROPER WORKING ORDER.
- CUT EXISTING GYPBOARD WALL AS REQUIRED TO INSTALL NEW FLUSH MOUNTED OUTLET BOX AND CONCEALED CONDUIT FOR NEW SWITCH. REPAIR EXISTING WALL AS REQUIRED.
- RECONNECT EXISTING ROOF MOUNTED EXHAUST FAN TO BE CONTROLLED BY NEW SWITCH FOR OUTBOARD LAMPS OF NEW F-2 FIXTURES. EXHAUST FAN IS CONNECTED THROUGH A 277-120 VOLT STEP DOWN TRANSFORMER - FIELD VERIFY EXISTING CONDITIONS.
- CONNECT ONE INBOARD LAMP OF 'EM' FIXTURES TO THE UNSWITCHED EMERGENCY LIGHTING CIRCUIT 'ELP-1'. CIRCUIT AND SWITCH TWO OUTBOARD LAMPS WITH GENERAL ROOM LIGHTING.
- CONNECT ONE INBOARD LAMP OF FIXTURES NOTED TO THE SWITCHED EMERGENCY LIGHT CIRCUIT 'ELP-3'. CIRCUIT AND SWITCH TWO OUTBOARD LAMPS WITH GENERAL ROOM LIGHTING.
- PROVIDE APPROVED BARRIER BETWEEN GANGED SWITCHES WHERE VOLTAGE BETWEEN ADJACENT SWITCHES EXCEEDS 300 VOLTS IN ACCORDANCE WITH NEC ARTICLE 404.8 (B).
- INSTALL 2' x 4', 3 LAMP LAY-IN PARABOLIC FLOURESCENT FIXTURE SALVAGED FROM DEMOLITION AND CONNECT AS INDICATED. CLEAN FIXTURE, RELAMP WITH NEW F32T/TL835 LAMPS, AND LEAVE IN PROPER WORKING ORDER.

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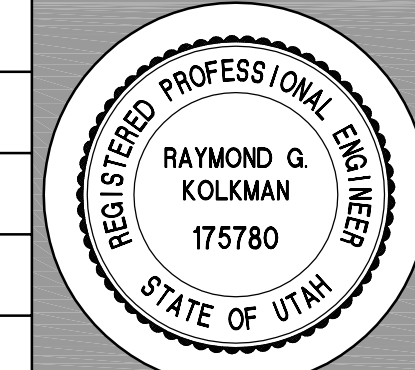
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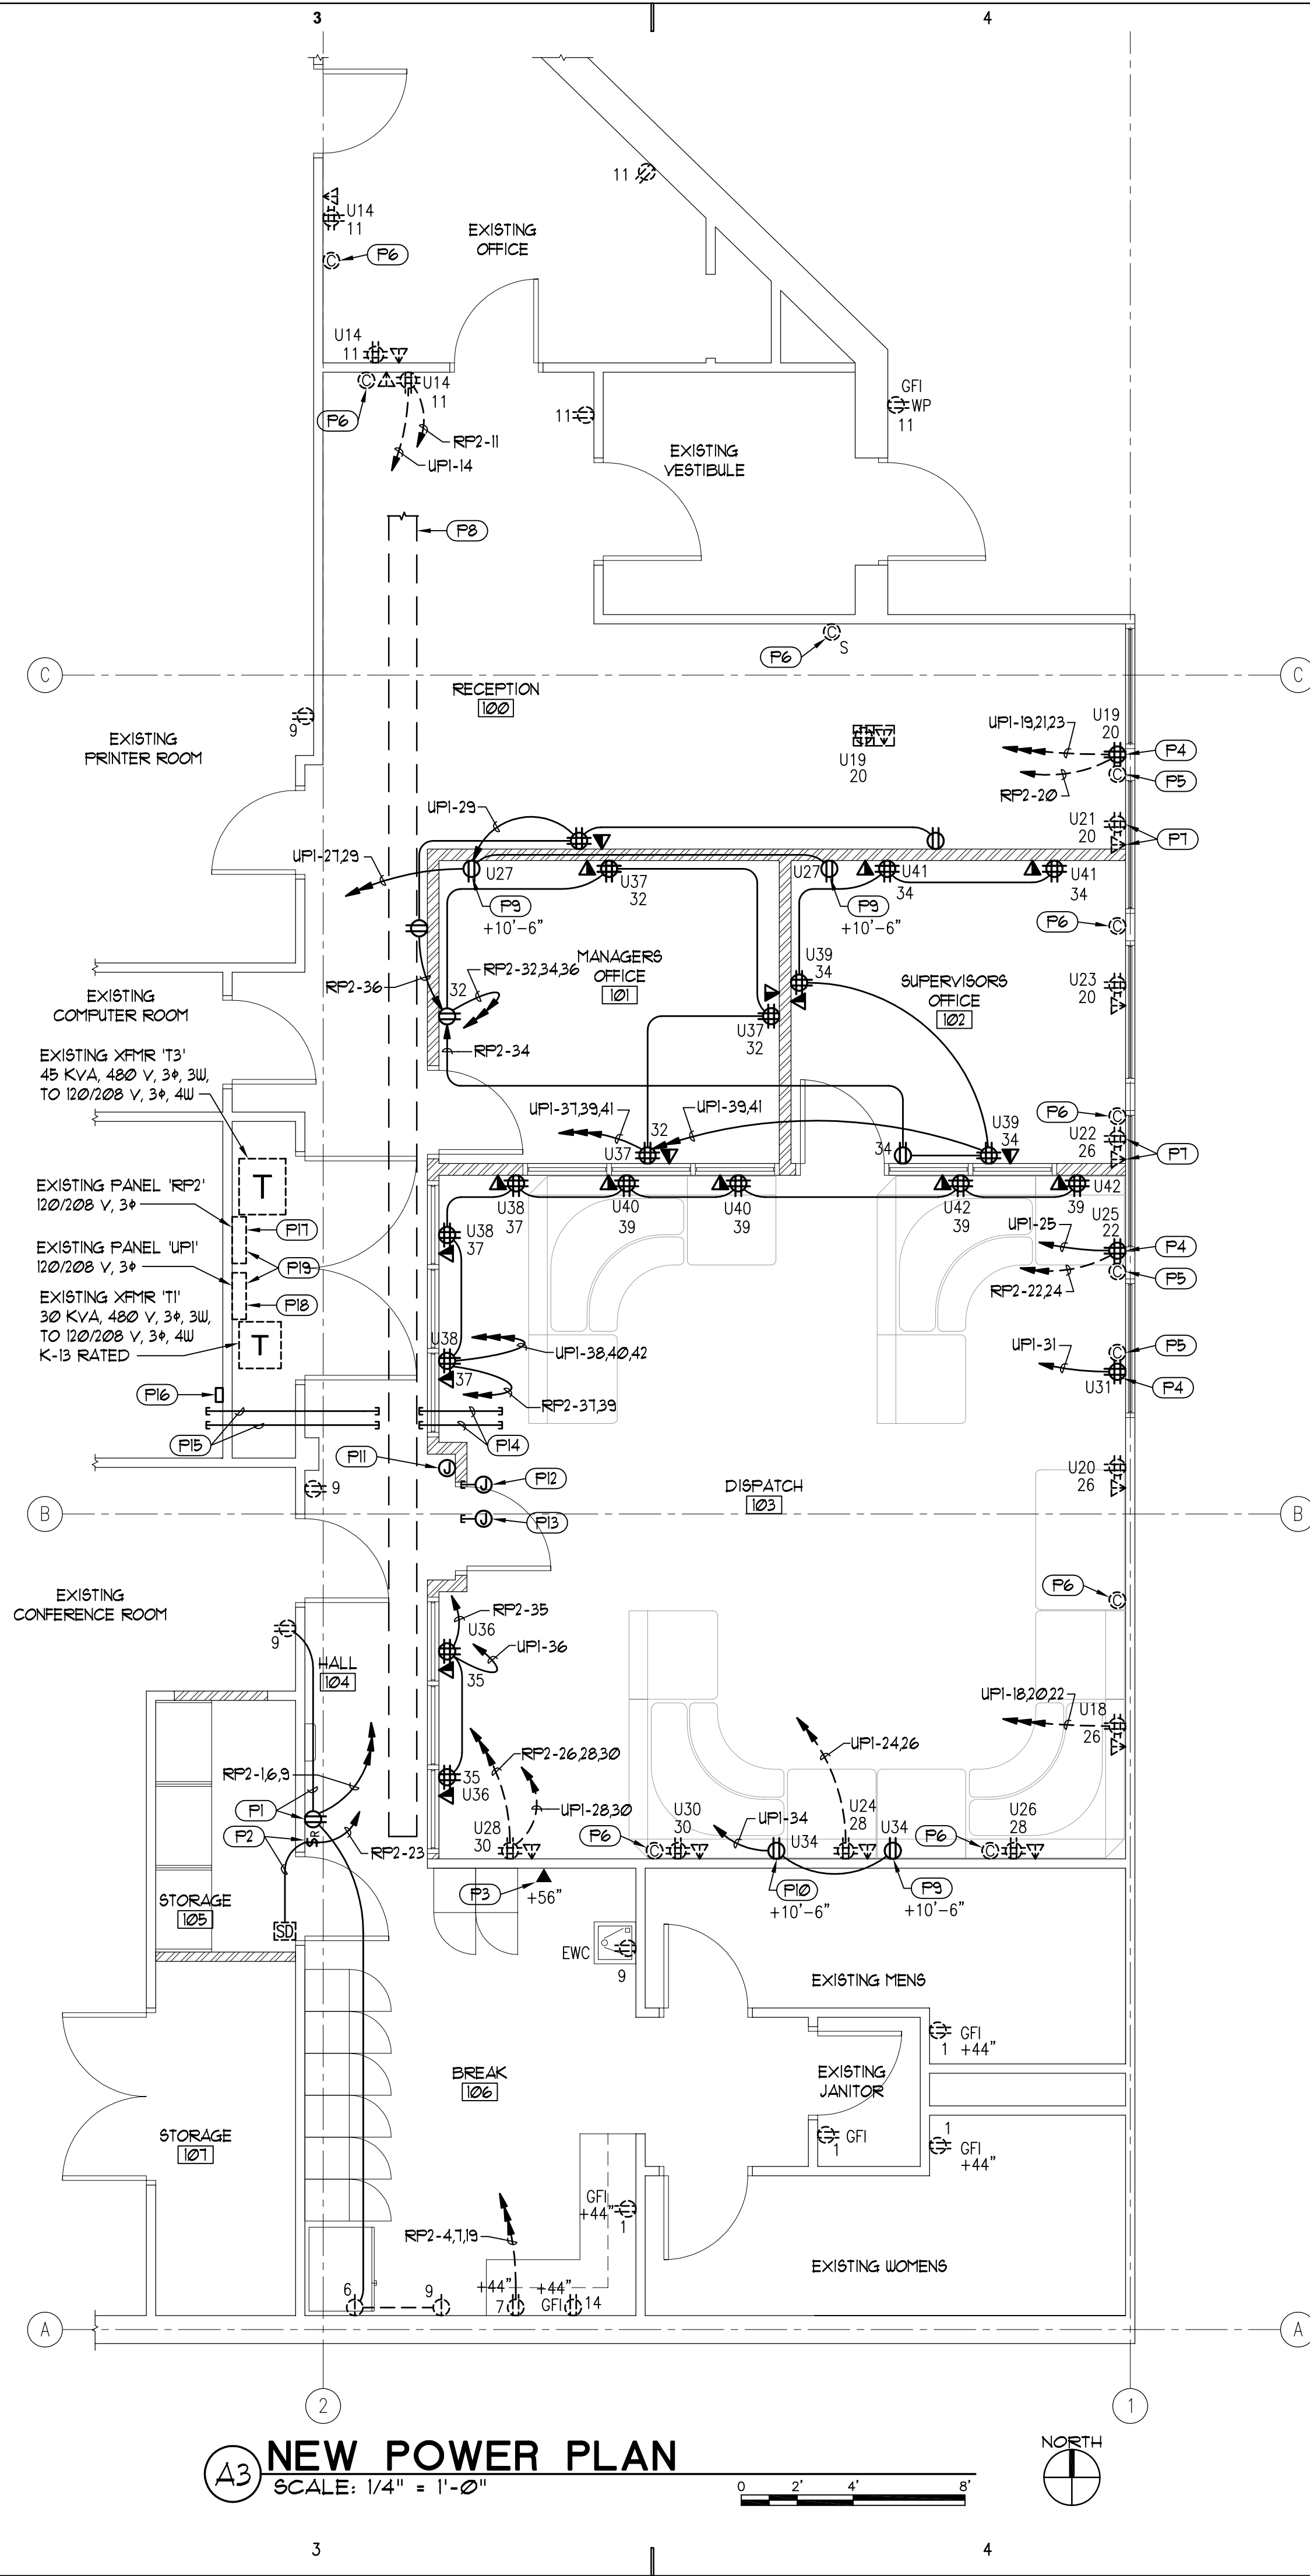
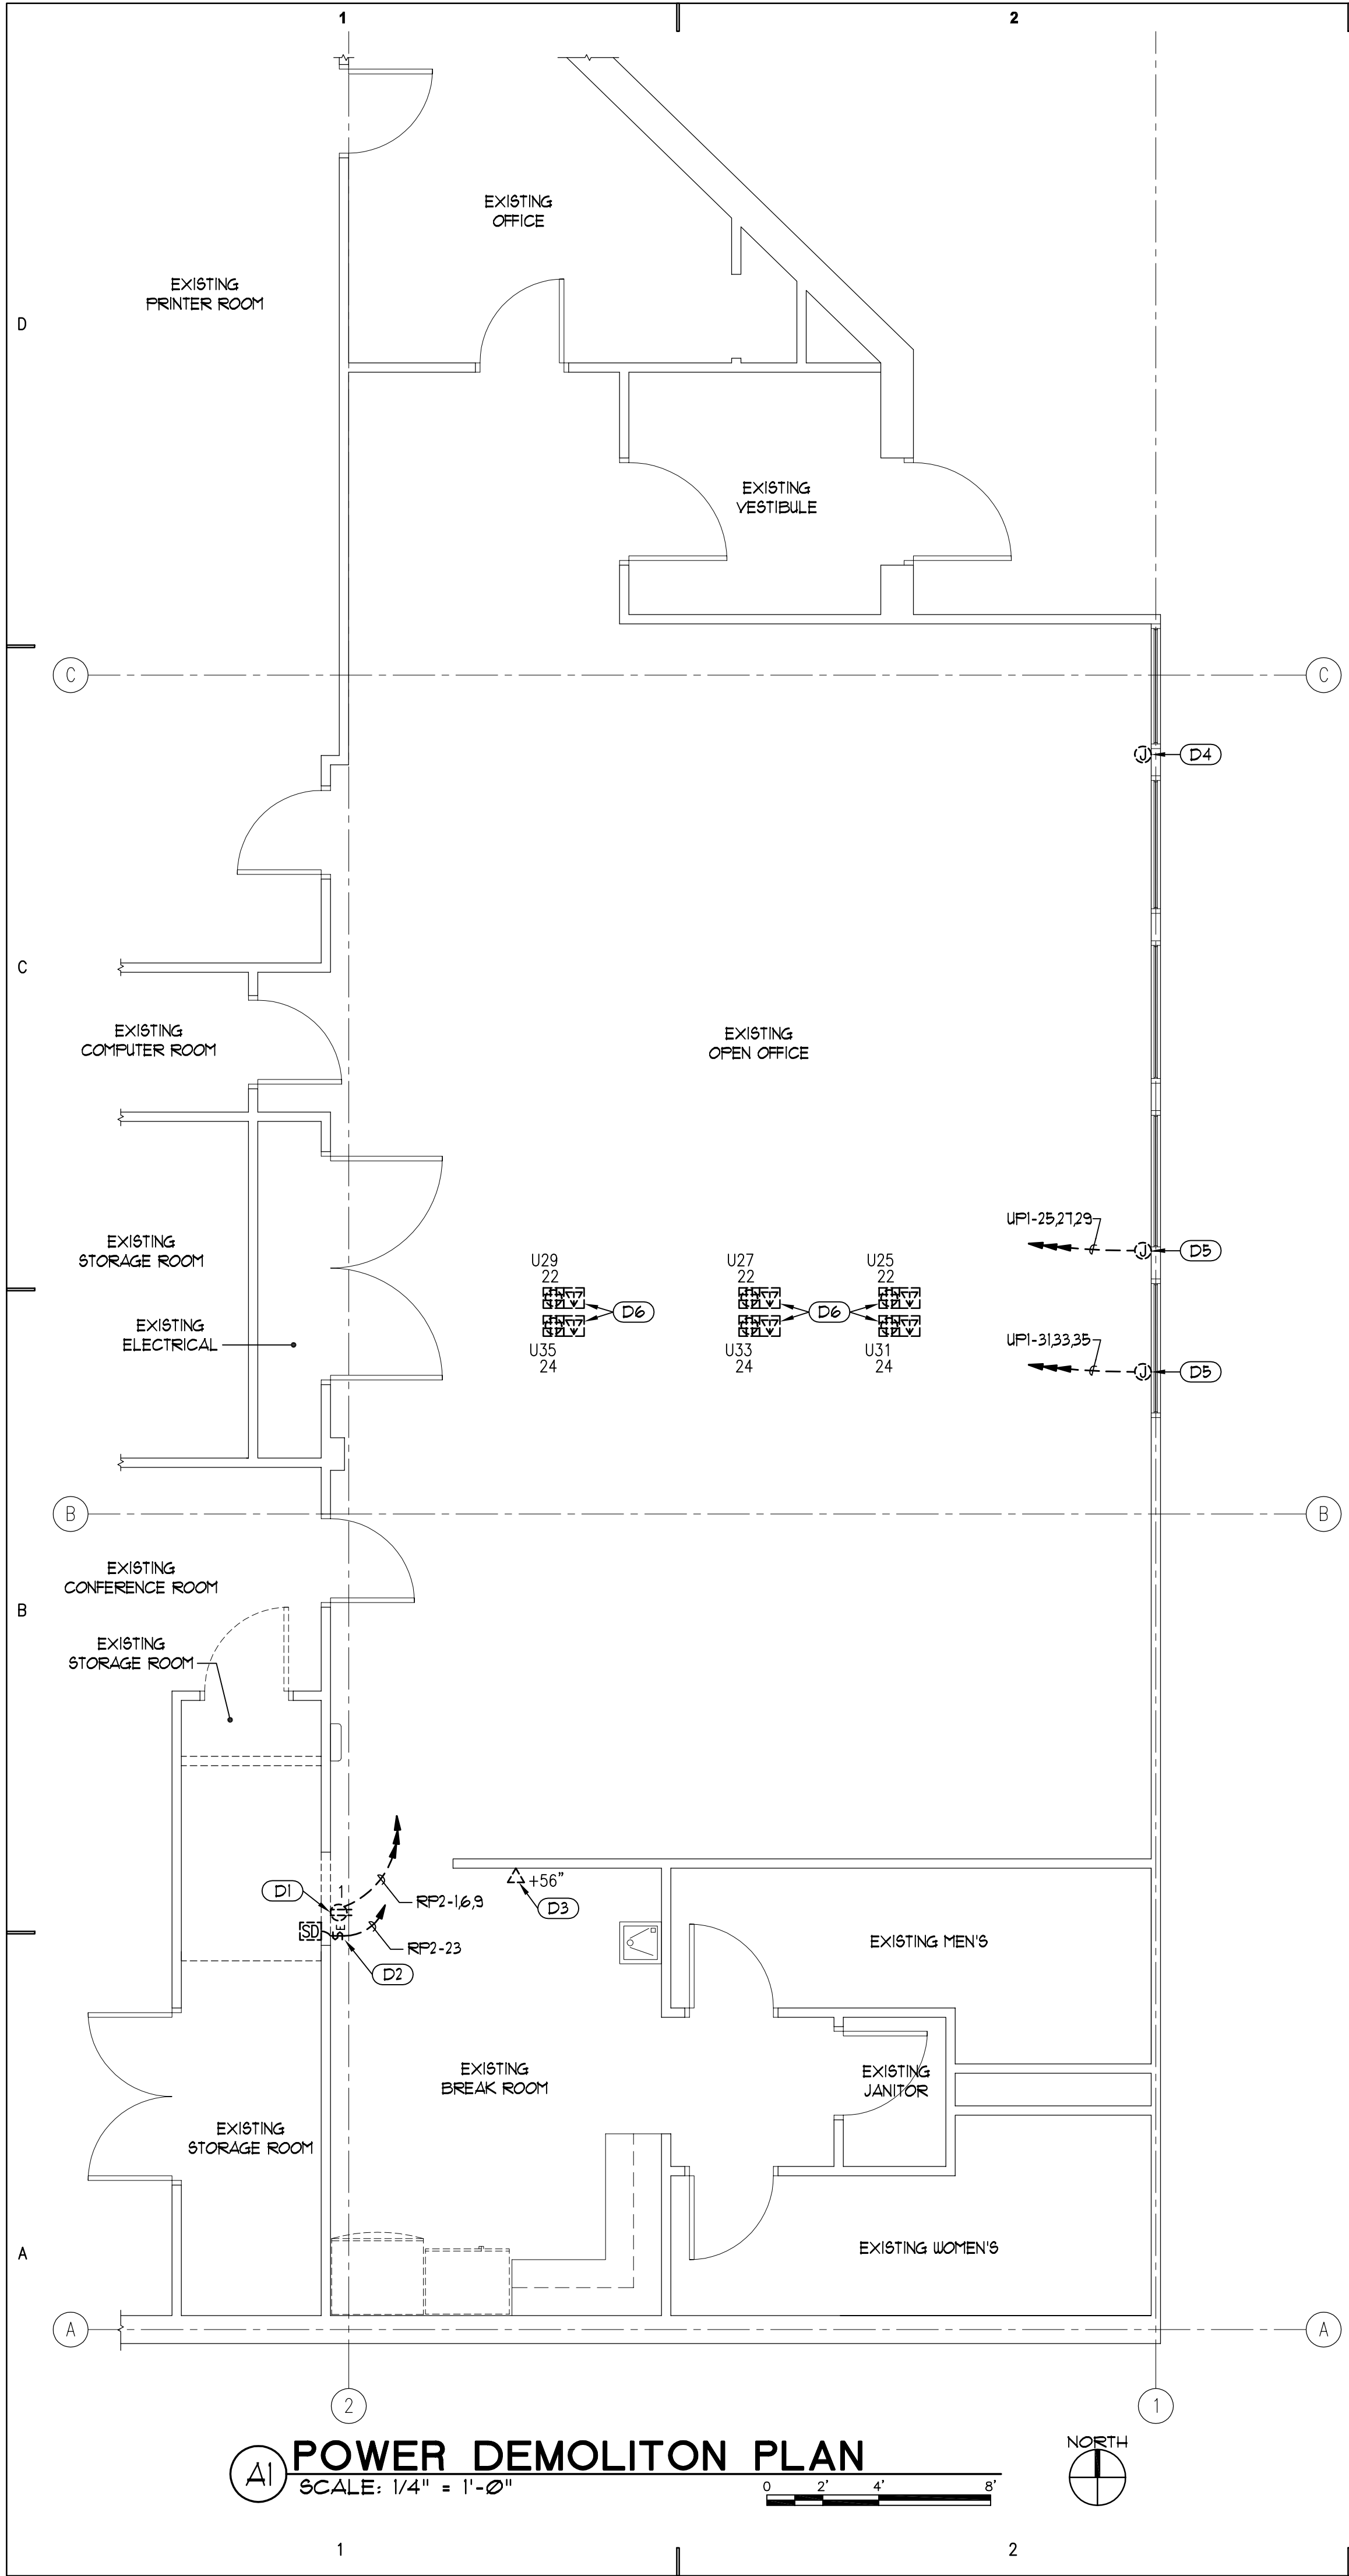
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LIGHTING PLANS

SHEET NO.
EL101



GENERAL NOTES:


- SEE GENERAL ELECTRICAL NOTES, SHEET E-101.
- FIELD COORDINATE LOCATION OF ALL NEW RECEPTACLES AND OUTLETS WITH OWNER'S FURNITURE LOCATIONS PRIOR TO ROUGHING IN.
- PROVIDE ISOLATED GROUND RECEPTACLES FOR ALL RECEPTACLES SERVED FROM PANEL UPI.
- PROVIDE A SEPARATE NEUTRAL FOR EACH NEW RECEPTACLE BRANCH CIRCUIT SHOWN FROM PANEL UPI AND PANEL RP2.
- PROVIDE AN INSULATED GREEN WITH YELLOW STRIPE GROUND CONDUCTOR IN EACH BRANCH CIRCUIT CONDUIT FROM PANEL UPI AND CONNECT TO THE GROUND TERMINAL OF ISOLATED GROUND RECEPTACLES. PROVIDE ADDITIONAL SAFETY GROUND IN ACCORDANCE WITH NEC ARTICLE 250-146 (d), FINE PRINT NOTE.
- PROVIDE AN INSULATED GREEN EQUIPMENT GROUND CONDUCTOR IN ALL BRANCH CIRCUIT RACEWAYS.

POWER DEMOLITON PLAN KEYED NOTES:


- REMOVE EXISTING RECEPTACLE INCLUDING ALL WIRING, CONDUIT, BOXES, SUPPORTS, ETC., AS REQUIRED TO ALLOW INSTALLATION OF NEW DOOR. RECONNECT EXISTING CIRCUITS AS SHOWN ON NEW POWER PLAN.
- REMOVE AND SALVAGE EXISTING SWITCH FOR SMOKE DAMPER INCLUDING ALL WIRING, CONDUIT, BOXES, SUPPORTS, ETC., AS REQUIRED TO ALLOW INSTALLATION OF NEW DOOR. RECONNECT EXISTING CIRCUIT AND SMOKE DAMPER AS SHOWN ON NEW POWER PLAN.
- REMOVE EXISTING WALL TELEPHONE OUTLET COMPLETE INCLUDING OUTLET BOX, WIRING, ACCESSIBLE CONDUIT, ETC. REPAIR EXISTING WALL AS REQUIRED TO ALLOW FOR INSTALLATION OF NEW LOCKERS, SEE ARCHITECT'S PLANS.
- EXISTING POWER OUTLET BOX FOR OFFICE FURNISHINGS CONNECTION TO REMAIN. REMOVE EXISTING CONNECTION TO OFFICE FURNISHINGS. REPLACE EXISTING SINGLE GANG PLASTER RING WITH NEW DOUBLE GANG PLASTER FOR INSTALLATION OF NEW DOUBLE DUPLEX RECEPTACLE AS SHOWN ON NEW POWER PLAN. REPAIR EXISTING WALL AS REQUIRED TO MATCH SURROUNDING SURFACES.
- REMOVE EXISTING BRANCH CIRCUIT WIRING TO EXISTING PANEL UPI. EXISTING CONDUIT TO REMAIN FOR INSTALLATION OF NEW WIRING SHOWN ON NEW POWER PLAN.
- REMOVE EXISTING DEVICES AND ALL WIRING FROM EXISTING FLOOR OUTLET BOXES AND ABANDON FLOOR BOXES IN PLACE. PROVIDE NEW BLANK COVERPLATE TO BE COVERED BY NEW CARPET.

NEW POWER PLAN KEYED NOTES:

- CUT EXISTING GYPBOARD WALL AS REQUIRED TO INSTALL NEW FLUSH MOUNTED OUTLET BOX AND CONCEALED CONDUIT FOR NEW RECEPTACLE. REPAIR EXISTING WALL AS REQUIRED. PROVIDE NEW CONDUIT AND WIRING AS REQUIRED TO RECONNECT EXISTING BRANCH CIRCUITS AS INDICATED.
- CUT EXISTING GYPBOARD WALL AS REQUIRED TO INSTALL NEW FLUSH MOUNTED OUTLET BOX AND CONCEALED CONDUIT FOR RELOCATED SMOKE DAMPER SWITCH. REPAIR EXISTING WALL AS REQUIRED. PROVIDE NEW CONDUIT AND WIRING AS REQUIRED TO RECONNECT EXISTING BRANCH CIRCUIT AND EXISTING SMOKE DAMPER AS INDICATED.
- CUT EXISTING GYPBOARD WALL AS REQUIRED TO INSTALL NEW FLUSH MOUNTED WALL TELEPHONE OUTLET AND CONCEALED 3/4" CONDUIT TO EXISTING COMMUNICATION CABLE TRAY. REPAIR EXISTING WALL AS REQUIRED.
- PROVIDE NEW DOUBLE DUPLEX RECEPTACLE IN EXISTING OFFICE FURNISHING OUTLET BOX AND CONNECT TO EXISTING CIRCUITS INDICATED.
- EXISTING TELE/DATA OUTLET BOX WITH 1" CONDUIT TO COMMUNICATION CABLE TRAY FOR OFFICE FURNISHINGS TO REMAIN. REMOVE CONNECTIONS TO OFFICE FURNISHINGS INCLUDING ABANDONED CABLES TO POINT OF ORIGIN. PROVIDE NEW BLANK COVERPLATE.
- EXISTING TELE/DATA OUTLET BOX WITH 1" CONDUIT TO COMMUNICATION CABLE TRAY TO REMAIN. SEE SHEET E-101 FOR CONTINUATION.
- FIELD VERIFY EXACT LOCATION OF EXISTING OUTLETS NEAR NEW WALLS. RELOCATE OR REMOVE OUTLETS AS REQUIRED TO ALLOW INSTALLATION OF NEW WALL AND PROVIDE ACCESS TO OUTLET BOXES.
- EXISTING 12" x 4" COMMUNICATION CABLE TRAY 11'-0" ABOVE FLOOR (11'-0" ABOVE CEILING) TO REMAIN.
- NEW RECEPTACLE 6" ABOVE NEW CEILING FOR BUILDING SECURITY SYSTEM MONITOR. VERIFY EXACT LOCATION WITH OWNER.
- NEW RECEPTACLE 6" ABOVE NEW CEILING FOR 52" TV MONITOR. VERIFY EXACT LOCATION WITH OWNER.
- PROVIDE OUTLET BOX WITH 3/4" CONDUIT TO ACCESSIBLE CEILING SPACE FOR NEW SECURITY SYSTEM CARD READER. VERIFY REQUIREMENTS WITH OWNER'S SECURITY SYSTEM VENDOR.
- PROVIDE 1/2" CONDUIT STUB FROM DOOR JAMB TO ACCESSIBLE CEILING SPACE FOR NEW SECURITY SYSTEM ELECTRIC DOOR STRIKE.
- PROVIDE 1/2" CONDUIT STUB FROM DOOR HEADER TO ACCESSIBLE CEILING SPACE FOR NEW SECURITY SYSTEM MAGNETIC DOOR CONTACTS.
- PROVIDE (2) 3" CONDUITS FROM EXISTING CABLE TRAY TO ACCESSIBLE CEILING SPACE OF DISPATCH ROOM. TERMINATE CONDUITS WITH GROUNDING BUSHINGS AND BOND TO EXISTING CABLE TRAY.
- PROVIDE (2) 3" CONDUITS FROM EXISTING CABLE TRAY TO ACCESSIBLE CEILING SPACE OF EXISTING STORAGE ROOM. TERMINATE CONDUITS WITH GROUNDING BUSHINGS AND BOND TO EXISTING CABLE TRAY.
- PROVIDE NEW WIREMOLD V6000, OR EQUAL, SURFACE METAL RACEWAY FROM EXISTING STORAGE ROOM CEILING SPACE TO RAISED FLOOR SPACE. PROVIDE NEW SUITABLE TRIM AT EXISTING RAISED FLOOR TILE. EXTEND RACEWAY 6" ABOVE CEILING AND 6" BELOW RAISED FLOOR AND TERMINATE EACH END WITH WIREMOLD V6000, OR EQUAL, PANEL CONNECTOR TO PROTECT CABLES FOR ABRASION.
- PROVIDE 8 NEW SIEMENS TYPE 'BL' BREAKERS IN EXISTING PANEL 'RP1'.
- PROVIDE 6 NEW SIEMENS TYPE 'BL' BREAKERS IN EXISTING PANEL 'UPI'.
- PROVIDE NEW TYPEWRITTEN CIRCUIT DIRECTORY FOR EXISTING PANELBOARDS TO REFLECT ALL CHANGES IN CIRCUITING.

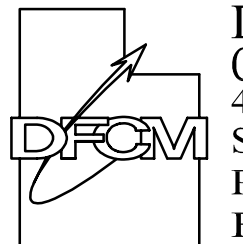


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PROJECT NAME & ADDRESS
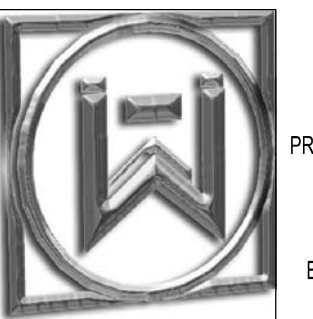
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DFCM No. 06298550

Richfield, Utah 84701

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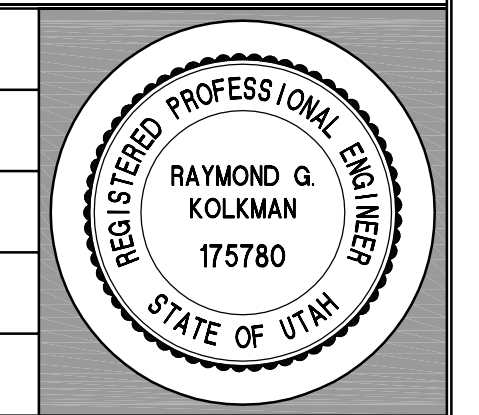
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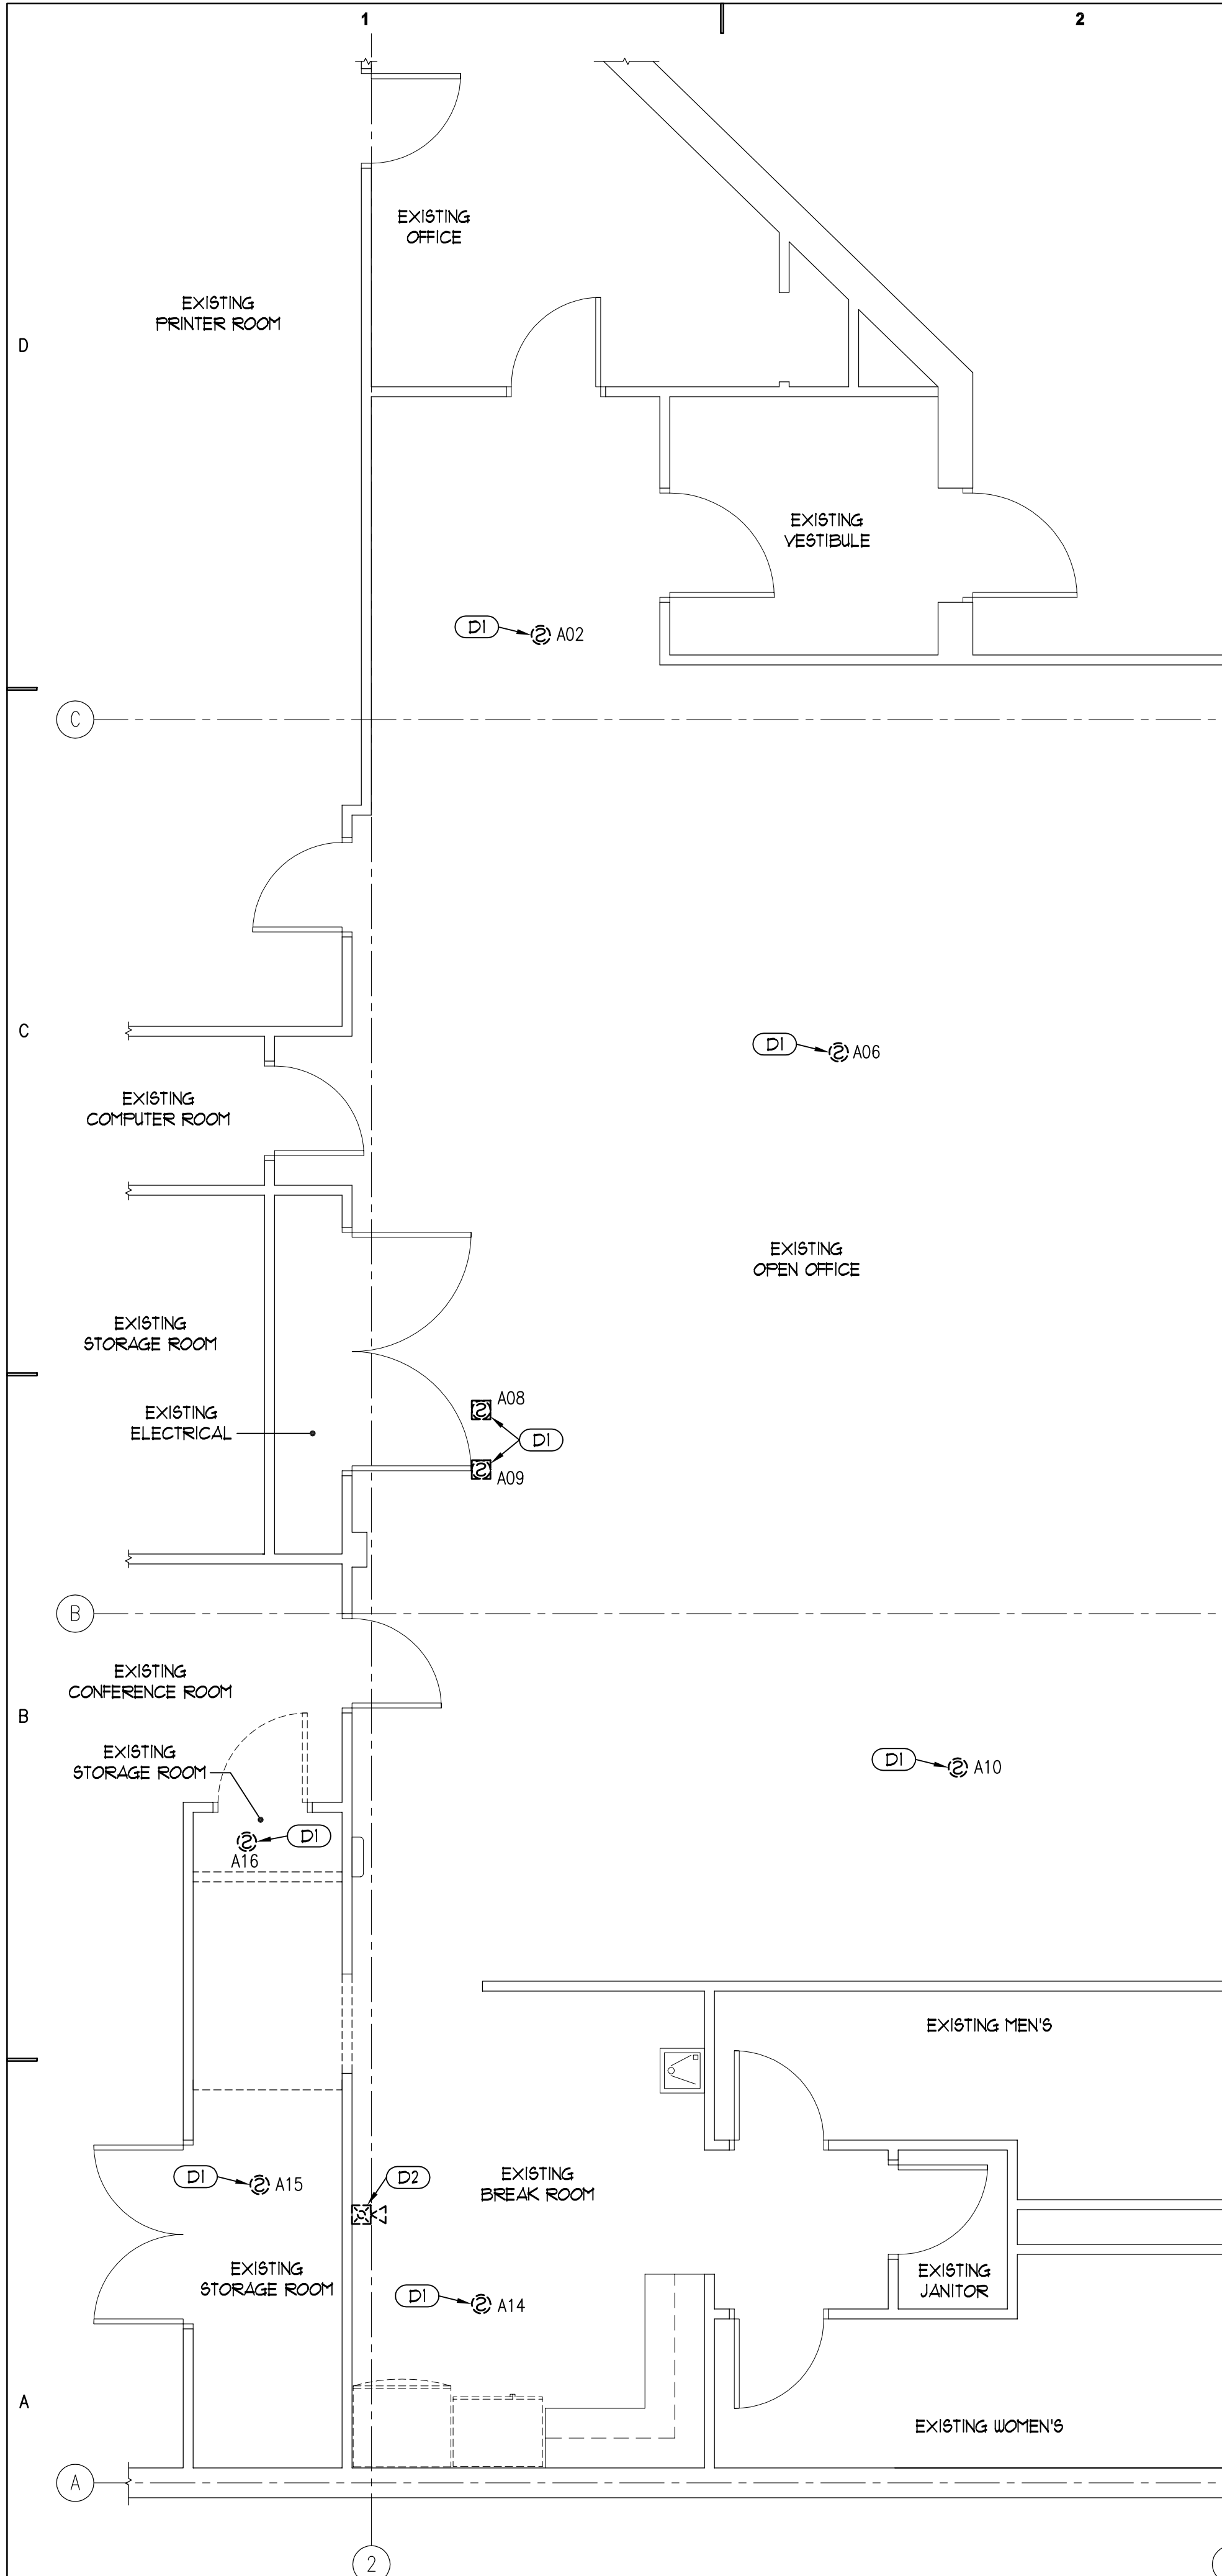
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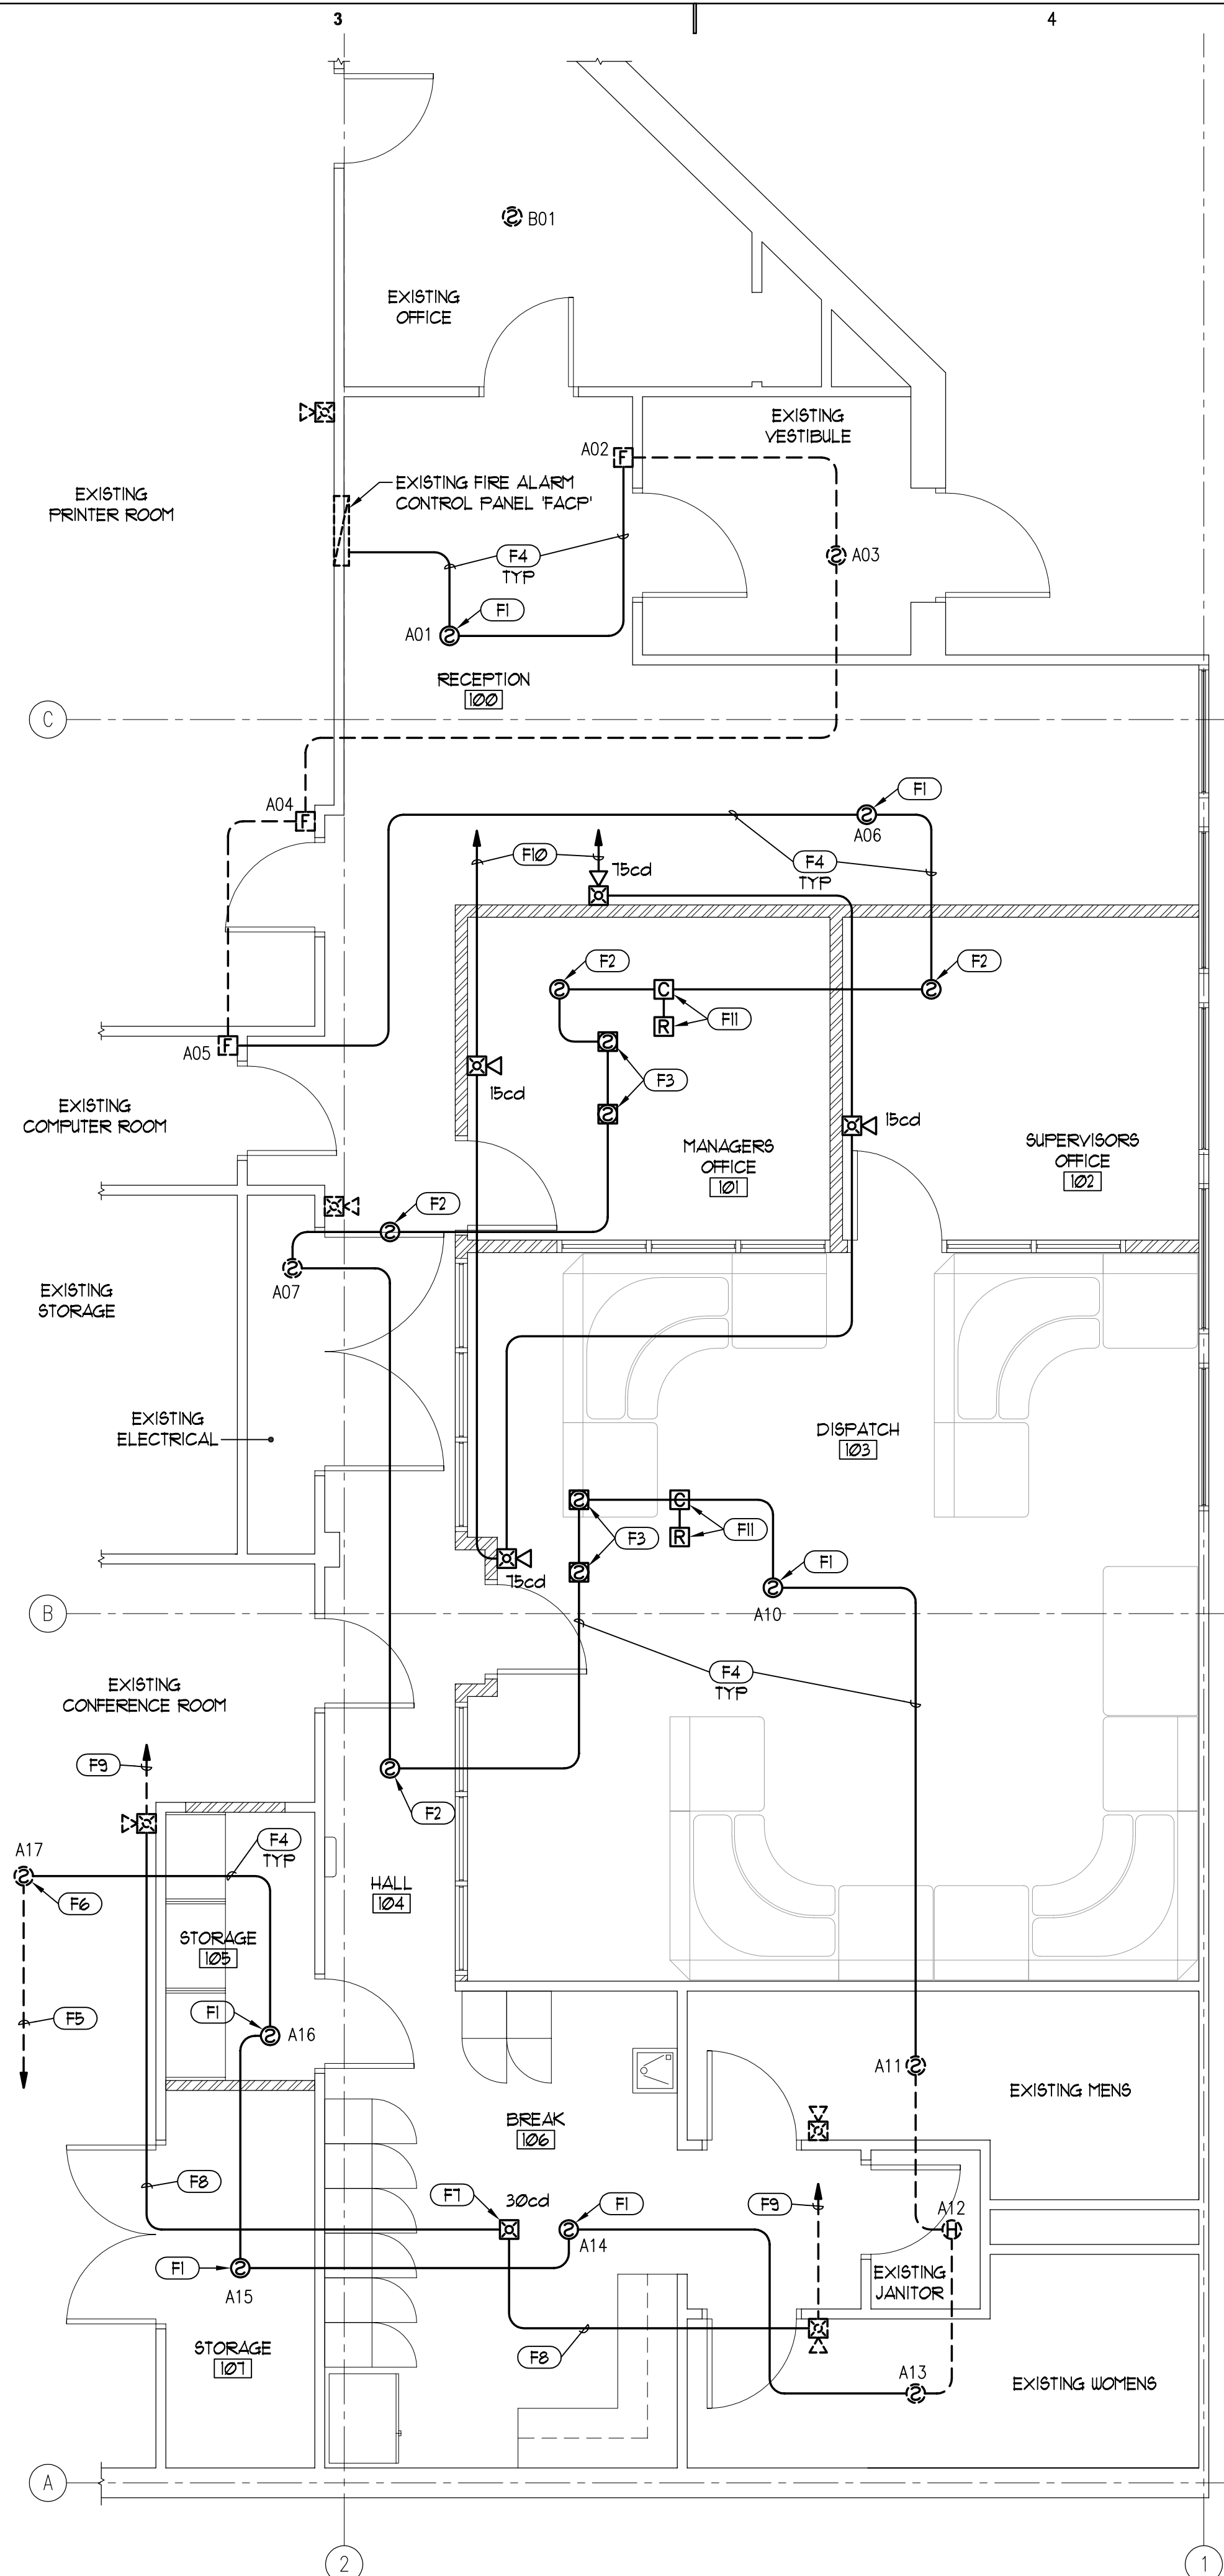
POWER PLANS

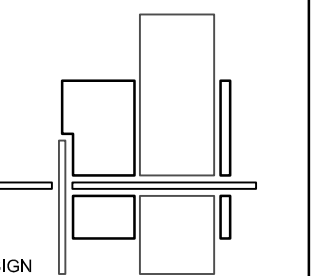SHEET NO.

EP101



A1 FIRE ALARM DEMOLITON PLAN
SCALE: 1/4" = 1'-0"
0 2' 4' 8'



A3 NEW FIRE ALARM PLAN
SCALE: 1/4" = 1'-0"
0 2' 4' 8'

- GENERAL NOTES:**
1. SEE GENERAL ELECTRICAL NOTES, SHEET E-101.
 2. THE EXISTING BUILDING IS PROTECTED THROUGHOUT BY AN AUTOMATIC FIRE ALARM SYSTEM WHICH IS TO REMAIN OPERATIONAL THROUGHOUT THE CONSTRUCTION PERIOD.
 3. SUBMIT REQUESTS FOR FIRE ALARM SYSTEM OUTAGES TO THE DFCM PROJECT MANAGER NOT LESS THAN 1 DAYS PRIOR TO ANY PROPOSED FIRE ALARM OUTAGES.
 4. IMMEDIATELY NOTIFY THE DFCM PROJECT MANAGER IF THE FIRE ALARM IS UNINTENTIONALLY DISABLED AND IMMEDIATELY MAKE REPAIRS TO RESTORE THE SYSTEM TO AN OPERATIONAL CONDITION.
 5. THE CONTRACTOR SHALL MAINTAIN A FIRE WATCH DURING ALL FIRE ALARM SYSTEM OUTAGES IN ACCORDANCE WITH IFC SECTION 901.1.
 6. ANY WORK PERFORMED ON THE FIRE ALARM SYSTEM SHALL BE APPROVED IN ADVANCE BY THE FIRE ALARM SYSTEM FACTORY REPRESENTATIVE. CONTACT SIMPLEX GRINNELL AT 801-262-9406.
 7. PROTECT EXISTING SMOKE AND HEAT DETECTORS IN AREAS OF CONSTRUCTION FROM EXCESSIVE DUST ACCUMULATION BY MEANS OF TEMPORARY DUST COVERS DURING DUST PRODUCING WORK OPERATIONS. REMOVE DUST COVERS IMMEDIATELY UPON COMPLETION OF DUST PRODUCING WORK.
 8. CLEAN ALL EXISTING AND RELOCATED SMOKE AND HEAT DETECTORS AFFECTED BY CONSTRUCTION IN ACCORDANCE WITH THE MANUFACTURER'S WRITTEN INSTRUCTIONS UPON COMPLETION OF WORK AND PRIOR TO SUBSTANTIAL COMPLETION.
 9. TEST ALL SMOKE AND HEAT DETECTORS AFTER CLEANING AND PRIOR TO SUBSTANTIAL COMPLETION. TESTING SHALL BE PERFORMED BY A FACTORY AUTHORIZED AND TRAINED TECHNICIAN OF THE FIRE ALARM SYSTEM MANUFACTURER. CONTACT SIMPLEX GRINNELL AT 801-262-9406.
 10. INITIATING DEVICE ADDRESS NUMBERS ARE EXISTING. COORDINATE NEW DEVICE ADDRESS NUMBERS AND EXISTING DEVICE ADDRESS NUMBER CHANGES WITH FIRE ALARM SYSTEM FACTORY TECHNICIAN. PROVIDE NEW ADDRESS LABELS FOR ALL NEW, RELOCATED, AND EXISTING DEVICES TO MATCH EXISTING ADDRESS LABELS.
 11. ALL EXISTING FIRE ALARM SYSTEM DEVICES SHOWN ARE TO REMAIN UNLESS NOTED OTHERWISE.

FIRE ALARM DEMOLITON PLAN KEYED NOTES:

- (D1) RELOCATE EXISTING SMOKE DETECTORS FROM EXISTING CEILING TO NEW CEILING AND RECONNECT EXISTING INITIATING DEVICE CIRCUIT. PROVIDE TEMPORARY SUPPORT AND CONNECTIONS AS REQUIRED TO KEEP EXISTING DETECTORS AND CIRCUITS OPERATIONAL THROUGHOUT DEMOLITION AND CONSTRUCTION. SEE GENERAL NOTE 2, THIS SHEET.
- (D2) REMOVE EXISTING FIRE ALARM HORN STROBE COMPLETE INCLUDING OUTLET BOX, WIRING, ACCESSIBLE CONDUIT, ETC. REPAIR EXISTING WALL AS REQUIRED TO ALLOW FOR INSTALLATION OF NEW LOCKERS, SEE ARCHITECT'S PLANS.
- (D3) REMOVE EXISTING DUCT MOUNTED SMOKE DETECTORS FROM EXISTING ROOFTOP UNIT TO BE REMOVED. DETECTORS ARE TO REMAIN OPERATIONAL UNTIL ROOFTOP UNIT IS SHUT DOWN FOR REMOVAL. PROVIDE TEMPORARY CONNECTIONS AS REQUIRED TO KEEP EXISTING CIRCUIT OPERATIONAL THROUGHOUT DEMOLITION AND CONSTRUCTION. SEE GENERAL NOTE 2, THIS SHEET.

NEW FIRE ALARM PLAN KEYED NOTES:

- (F1) EXISTING SMOKE DETECTOR RELOCATED FROM EXISTING CEILING TO NEW CEILING.
- (F2) PROVIDE NEW SMOKE DETECTOR IN NEW CEILING.
- (F3) EXISTING DUCT MOUNTED SMOKE DETECTORS RELOCATED FROM EXISTING ROOFTOP UNIT DUCTWORK TO NEW ROOFTOP UNIT RTU/1 SUPPLY AND RETURN AIR DUCTS.
- (F4) PROVIDE NEW DUCT MOUNTED SMOKE DETECTORS ON NEW ROOFTOP UNIT RTU/2 SUPPLY AND RETURN AIR DUCTS.
- (F5) PROVIDE NEW SIGNALING LINE CIRCUIT WIRING AND CONDUIT AS REQUIRED FOR CONNECTION OF NEW, RELOCATED, AND EXISTING INITIATING DEVICES.
- (F6) EXISTING SIGNALING LINE CIRCUIT TO OTHER BUILDING INITIATING DEVICES AND RETURN CLASS A LOOP TO EXISTING FIRE ALARM CONTROL PANEL TO REMAIN.
- (F7) EXISTING SMOKE DETECTOR 'A1' LOCATED IN RAISED FLOOR SPACE OF EXISTING CONFERENCE ROOM.
- (F8) PROVIDE NEW CEILING MOUNTED HORN/STROBE COMBINATION IN BREAK ROOM TO REPLACE WALL MOUNTED HORN/STROBE REMOVED BY DEMOLITION.
- (F9) PROVIDE NEW NOTIFICATION APPLIANCE CIRCUIT WIRING AND CONDUIT AS REQUIRED FOR CONNECTION OF NEW AND EXISTING NOTIFICATION APPLIANCES.
- (F10) EXISTING NOTIFICATION APPLIANCE CIRCUIT TO OTHER BUILDING NOTIFICATION APPLIANCES CLASS A LOOP TO EXISTING FIRE ALARM CONTROL PANEL TO REMAIN.
- (F11) PROVIDE NEW CLASS A, STYLE Z, NOTIFICATION APPLIANCE CIRCUIT TO EXISTING FIRE ALARM CONTROL PANEL FOR NEW HORN/STROBES AS INDICATED.
- (F12) PROVIDE NEW ADDRESSABLE CONTROL MODULE AND NEW POWER RELAY FOR FAN SHUT DOWN OF NEW ROOFTOP UNITS. SEE TYPICAL FAN SHUT DOWN CONTROL WIRING DIAGRAM, SHEET E-601. PROGRAM CONTROL MODULES TO SHUT DOWN SUPPLY AIR FAN UPON ACTIVATION OF DUCT SMOKE DETECTORS OR ANY INITIATING DEVICE WITHIN THE AREAS SERVED BY THE ROOFTOP UNITS. FIELD COORDINATE CONNECTIONS WITH MECHANICAL CONTRACTOR AND FIRE ALARM SYSTEM TECHNICIAN.

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SHEET TITLE
FIRE ALARM PLANS

REGISTERED PROFESSIONAL ENGINEER
RAYMOND G. KOLKMAN
175780
STATE OF UTAH

SHEET NO.
FA101

